

SITE SUMMARY

SITE TYPE NEW SITE DESIGN TOWER TYPE MONOPOLE TOWER HEIGHT 145'-0 APPURTENANCE HEIGHT 155'-0 TOWER ELEVATION (AMSL): 133.4'±

WIND LOAD: 140 MPH, RISK CATEGORY II TYPE OF OCCUPANCY: **TELECOMMUNICATIONS** 27° 59' 53.17" N (27.998103°) TOWER LATITUDE: TOWER LONGITUDE: 81° 47' 04.41" W (-81.784558°

ZONING JURISDICTION: POLK COUNTY COUNTY: POLK

APN # 252835000000023020 ZONING: UNPLATTED

PARCEL SIZE: 337.733 SQ FT LEASE AREA SIZE: 6.400± SF 0.0147± ACRES

POWER COMPANY: TAMPA ELECTRIC TELEPHONE COMPANY: **FRONTIER**

LAND OWNER EDWARD BOLICK 3024 SPIRIT LAKE DRIVE WINTER HAVEN, FL 33880 CONTACT: EDWARD BOLICK PHONE: (863) 514-7047 CO-APPLICANT/CARRIER: T-MOBILE 5901 BENJAMIN CENTER DR, SUITE 110 A-B TAMPA, FL 33634 CONTACT: BETH FASSLER PHONE: (740) 310-4983 APPLICANT/TOWER OWNER: VB BTS II. LLC 750 PARK OF COMMERCE DR, SUITE 200 BOCA RATON, FLORIDA 33487 CONTACT: TERYLE WIEGEL PHONE: (425) 761-4323 SITE DESIGN/ENGINEER: FDH INFRASTRUCTURE SERVICES 6521 MERIDIEN DRIVE RALEIGH, NC 27616 CONTACT: JAMES R. BILLUPS, PE, CFM PHONE: (919) 755-1012 SURVEYOR: SMW ENGINEERING GROUP, INC. 12979 N TELECOM PARKWAY TAMPA, FL 33637

CONTACT: JOHNNY L. FLASKAMP

PHONE: (813) 615-1422

PROJECT DIRECTORY

CONSTRUCTION DRAWINGS

VB BTS II, LLC

VB BTS, LLC SITE ID/NAME:

US-FL-7140 / HUNGRY HOWIE

T-MOBILE SITE ID: A2B2227A

SITE ADDRESS: SPIRIT LAKE ROAD WINTER HAVEN, FL 33880 (UNVERIFIED)

SCOPE OF WORK

VB BTS, LLC. PROPOSES TO INSTALL AN UNMANNED TELECOMMUNICATIONS FACILITY CONSISTING OF A 145'-0" MONOPOLE TOWER WITH 10' LIGHTNING ROD, THE TOWER WILL BE PLACED INSIDE A 60'-0"¥60'-0" FENCED COMPOLIND, INSIDE 80'-0"¥80'-0" LEASE/ FASEMENT AREA T-MOBILE PROPOSES TO INSTALL AN UNMANNED TELECOMMUNICATIONS FACILITY CONSISTING OF MOUNTING ANTENNAS AND ANCILLARY EQUIPMENT ON THE PROPOSED 145'-0" MONOPOLE TOWER. THE RELATED EQUIPMENT CABINETS AND ACCESSORIES WILL BE PLACED ON A PROPOSED EQUIPMENT PLATFORM ADJACENT TO THE TOWER INSIDE THE 80'-0"x80'-0" LEASE/EASEMENT AREA

NOTE: ANY CHANGES TO THE APPROVED PLANS MUST BE APPROVED BY THE PROPERTY OWNER.

DIRECTIONS

FROM ORLANDO INTERNATIONAL AIRPORT, ORLANDO, FL:

GET ON FL-528 W/FL-528 TOLL W. HEAD NORTH ON ACCESS RD/JEFF FUQUA BLVD. CONTINUE TO FOLLOW JEFF FUQUA BLVD. USE THE RIGHT LANE TO TAKE THE RAMP ONTO EL-528 W/EL-528 TOLL W. FOLLOW FL-528 W/EL-528 TOLL W. I-4 W AND FL-570 W/POLK PKWY TO EL-540 F. IN POLK COUNTY. TAKE EXIT 14 FROM FL-570 W/POLK PKWY. MERGE ONTO FL-528 W/FL-528 TOLL W. USE THE LEFT 2 LANES TO MERGE ONTO I-4 W TOWARD TAMPA. TAKE EXIT 41 FOR FL-570 W TOWARD AUBURNDALE/LAKELAND/POLK PKWY. CONTINUE ONTO FL-570 W/POLK PKWY. TAKE EXIT 14 TO MERGE ONTO FL-540 E. FOLLOW FL-540 E TO SPIRIT LAKE DR. MERGE ONTO FL-540 E. SHARP RIGHT ONTO SPIRIT LAKE RD. TURN LEFT ONTO SPIRIT LAKE DR. DESTINATION WILL BE ON THE RIGHT.

CODE COMPLIANCE

ALL WORK AND MATERIALS SHALL BE PERFORMED AND INSTALLED IN ACCORDANCE WITH THE CURRENT EDITIONS OF THE FOLLOWING CODES AS ADOPTED BY THE LOCAL GOVERNING AUTHORITIES. NOTHING IN THESE PLANS IS TO BE CONSTRUED TO PERMIT WORK NOT CONFORMING TO THE LATEST EDITIONS OF THE FOLLOWING:

- FLORIDA BUILDING CODE 2020 ANSI/TIA-222-H
- NATIONAL ELECTRIC CODE 2017

- LOCAL BUILDING CODE
- CITY/COUNTY ORDINANCES
- 2020 FLORIDA FIRE PREVENTION CODE ASCE 7-16 RISK CATEGORY II WIND SPEED

GENERAL NOTES

THE FACILITY IS UNMANNED AND NOT FOR HUMAN HABITATION, THEREFORE HANDICAR ACCESS IS NOT REQUIRED. A TECHNICIAN WILI VISIT THE SITE AS REQUIRED FOR ROUTINI MAINTENANCE THE PROJECT WILL NOT RESULT IN ANY SIGNIFICANT DISTURBANCE OR EFFECT ON DRAINAGE; NO SANITARY SEWER SERVICE POTABLE WATER, OR TRASH DISPOSAL IS REQUIRED AND NO COMMERCIAL SIGNAGE IS PROPOSED.



UNDERGROUND SERVICE ALERT UTILITIES PROTECTION CENTER, INC.

48 HOURS BEFORE YOU DIG

LEGAL DESCRIPTION

REFER TO TOPOGRAPHICAL SURVEY AND SITE PLAN FOR LEGAL DESCRIPTION OF PARENT PARCEL AND LEASE AREA.



SHEET INDEX						
SHEET	DESCRIPTION	REV. NO.	DATE			
NO. T-1	TITLE SHEET	0	03/17/2023			
SU-1	SURVEY SHEET	<u> </u>	11/03/2022			
SU-2	SURVEY SHEET	_	11/03/2022			
SU-3	SURVEY SHEET	_	11/03/2022			
SU-4	SURVEY SHEET	_	11/03/2022			
SU-5	SURVEY SHEET	_	11/03/2022			
GN-1	GENERAL NOTES	0	03/17/2023			
GN-2	GENERAL NOTES	0	03/17/2023			
GN-3	GENERAL NOTES	0	03/17/2023			
GN-4	GENERAL NOTES	0	03/17/2023			
GN-5	SIGN DETAILS	0	03/17/2023			
Z-1	ZONING & LAND USE	0	03/17/2023			
Z-2	ZONING & LAND USE	0	03/17/2023			
C-1	SITE PLAN	0	03/17/2023			
C-1.1	AERIAL SITE PLAN	0	03/17/2023			
C-1.2	SOIL SITE PLAN	0	03/17/2023			
C-2	COMPOUND DETAILS	0	03/17/2023			
C-2.1	T-MOBILE EQUIPMENT LAYOUT	0	03/17/2023			
C-3	GRADING & EROSION CONTROL PLAN	0	03/17/2023			
C-3.1	GRADING DETAILS	0	03/17/2023			
C-4	FENCE DETAILS	0	03/17/2023			
C-4.1	CATTLE GATE DETAILS	0	03/17/2023			
C-5	PIER, GPS, & GROUND CONSTRUCTION DETAILS	0	03/17/2023			
C-5.1	T-MOBILE CABINET DETAILS	0	03/17/2023			
C-6	T-MOBILE ANTENNA LAYOUT & DETAILS	0	03/17/2023			
C-6.1	T-MOBILE ANTENNA LAYOUT & DETAILS	0	03/17/2023			
C-6.2	T-MOBILE SYSTEM CONNECTION DIAGRAM	0	03/17/2023			
E-1	COMPOUND ELECTRICAL PLAN	0	03/17/2023			
E-1.1	T-MOBILE EQUIPMENT ELECTRICAL PLAN	0	03/17/2023			
E-2	METER & TELCO RACK	0	03/17/2023			
E-2.1	T-MOBILE EQUIPMENT RACK DETAIL	0	03/17/2023			
E-2.2	T-MOBILE EQUIPMENT RACK DETAIL	0	03/17/2023			
E-3	ELECTRICAL DETAILS	0	03/17/2023			
E-4	SINGLE LINE DIAGRAM	0	03/17/2023			
G-1	COMPOUND GROUNDING PLAN	0	03/17/2023			
G-1.1	T-MOBILE GROUNDING PLAN	0	03/17/2023			
G-2	GROUNDING DETAILS	0	03/17/2023			
G-3	GROUNDING DETAILS	0	03/17/2023			
G-4	GROUNDING NOTES	0	03/17/2023			
SN-1	PLATFORM STRUCTURAL NOTES 1	0	03/17/2023			
SN-2	PLATFORM STRUCTURAL NOTES 2	0	03/17/2023			
S-1	PLATFORM FOUNDATION DETAILS	0	03/17/2023			
S-2	PLATFORM FRAMING PLAN	0	03/17/2023			
S-3	PLATFORM PROFILES	0	03/17/2023			
S-4	PLATFORM CONNECTION DETAILS I	0	03/17/2023			
S-5	PLATFORM CONNECTION DETAILS II	0	03/17/2023			
S-6	PLATFORM CONNECTION DETAILS III	0	03/17/2023			
S-6	PLATFORM CONNECTION DETAILS III PLATFORM CONNECTION DETAILS IV	0	03/17/2023			
5-7 L-1	LANDSCAPE SITE PLAN	0	03/17/2023			
L-1	LANDOOAFE SITE FEAN	+ "	03/11/2023			

BTS II, LLC

750 PARK OF COMMERCE DR, SUITE 200 BOCA RATON, FL 33487





ENGINEERING INNOVATION

THE INFORMATION CONTAINED IN THIS SET OF DOCUMENTS IS PROPRIETARY BY NATURE. REPRODUCTION OR CAUSING TO BE REPRODUCED THE WHOLE OR ANY PART OF THESE DRAWINGS WITHOUT THE PERMISSION OF FDH IS PROHIBITED.

SUBMITTALS					
REV	DATE	DESCRIPTION	BY	CHK'D	
0	03/17/2023	CONSTRUCTION	ZK	JRB	



FDH INFRASTRUCTURE SERVICES, LLC DENNIS D. ABEL, PE STATE LICENNSE NO. 62750

FDH JOB NUMBER:

PR-008353

US-FL-7140

SITE NAME: HUNGRY HOWIE

T-MOBILE SITE ID:

A2B2227A

252835000000023020

ADDRESS:


3024 SPIRIT LAKE DRIVE WINTER HAVEN, FL 33880


SHEET TITLE:


TITLE SHEET


SHEET NUMBER:

T-1

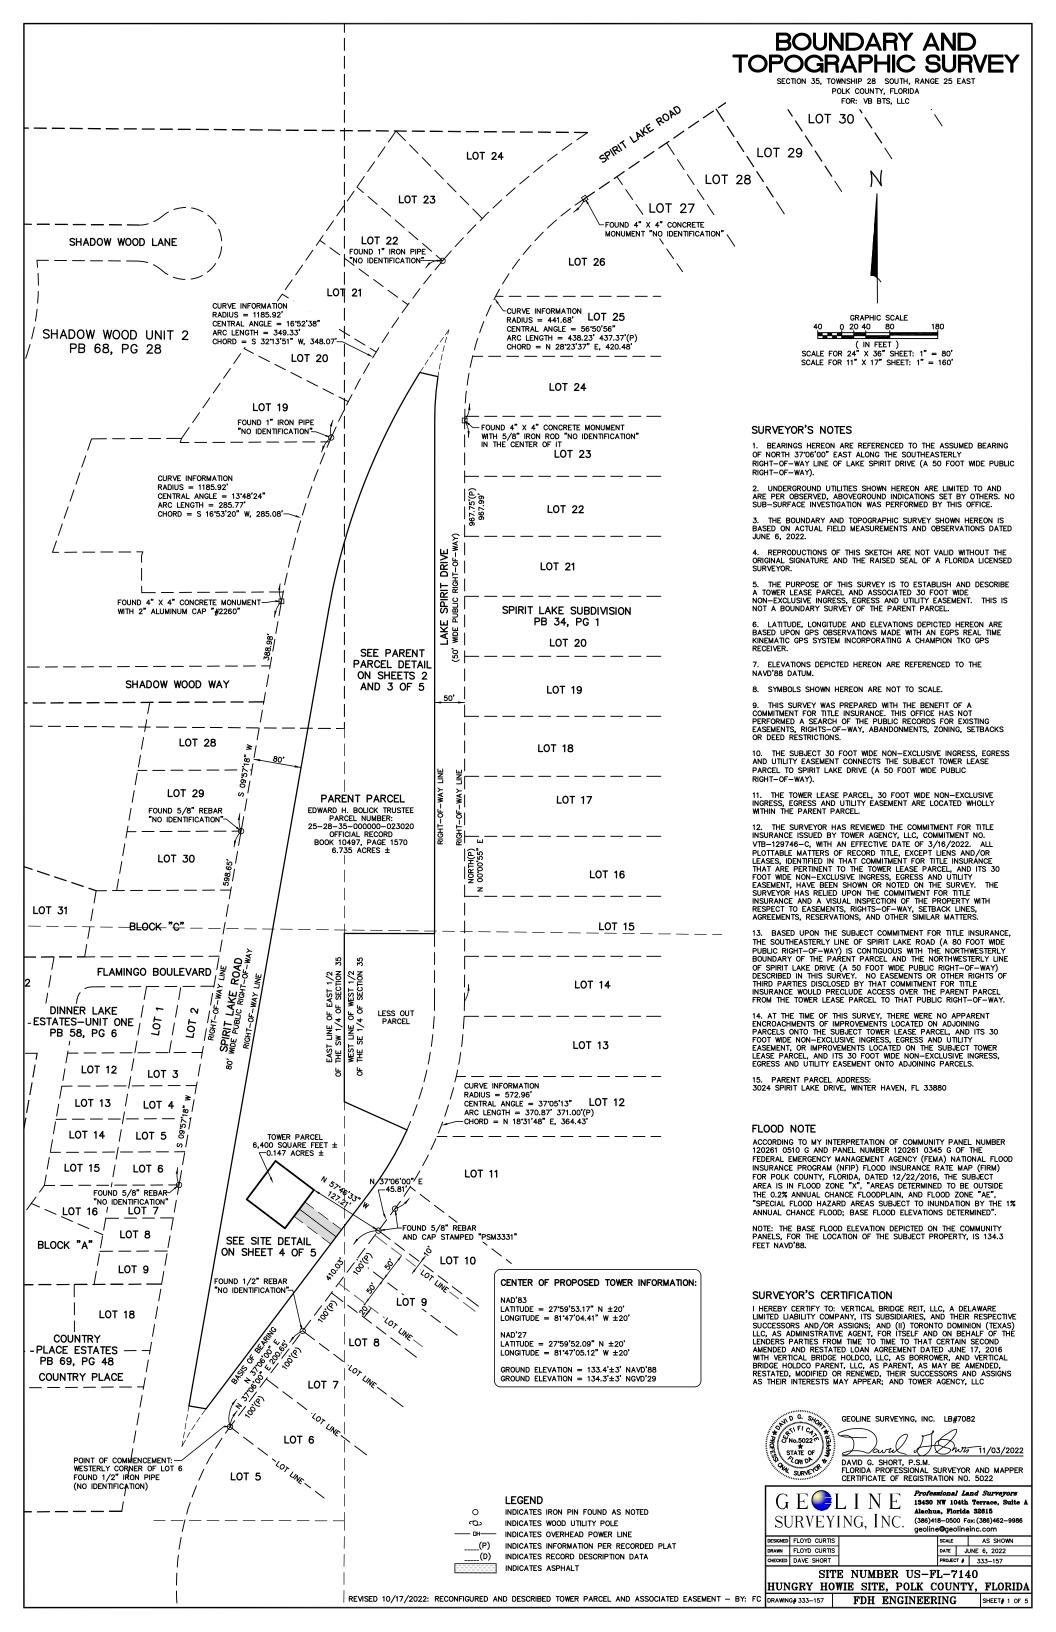

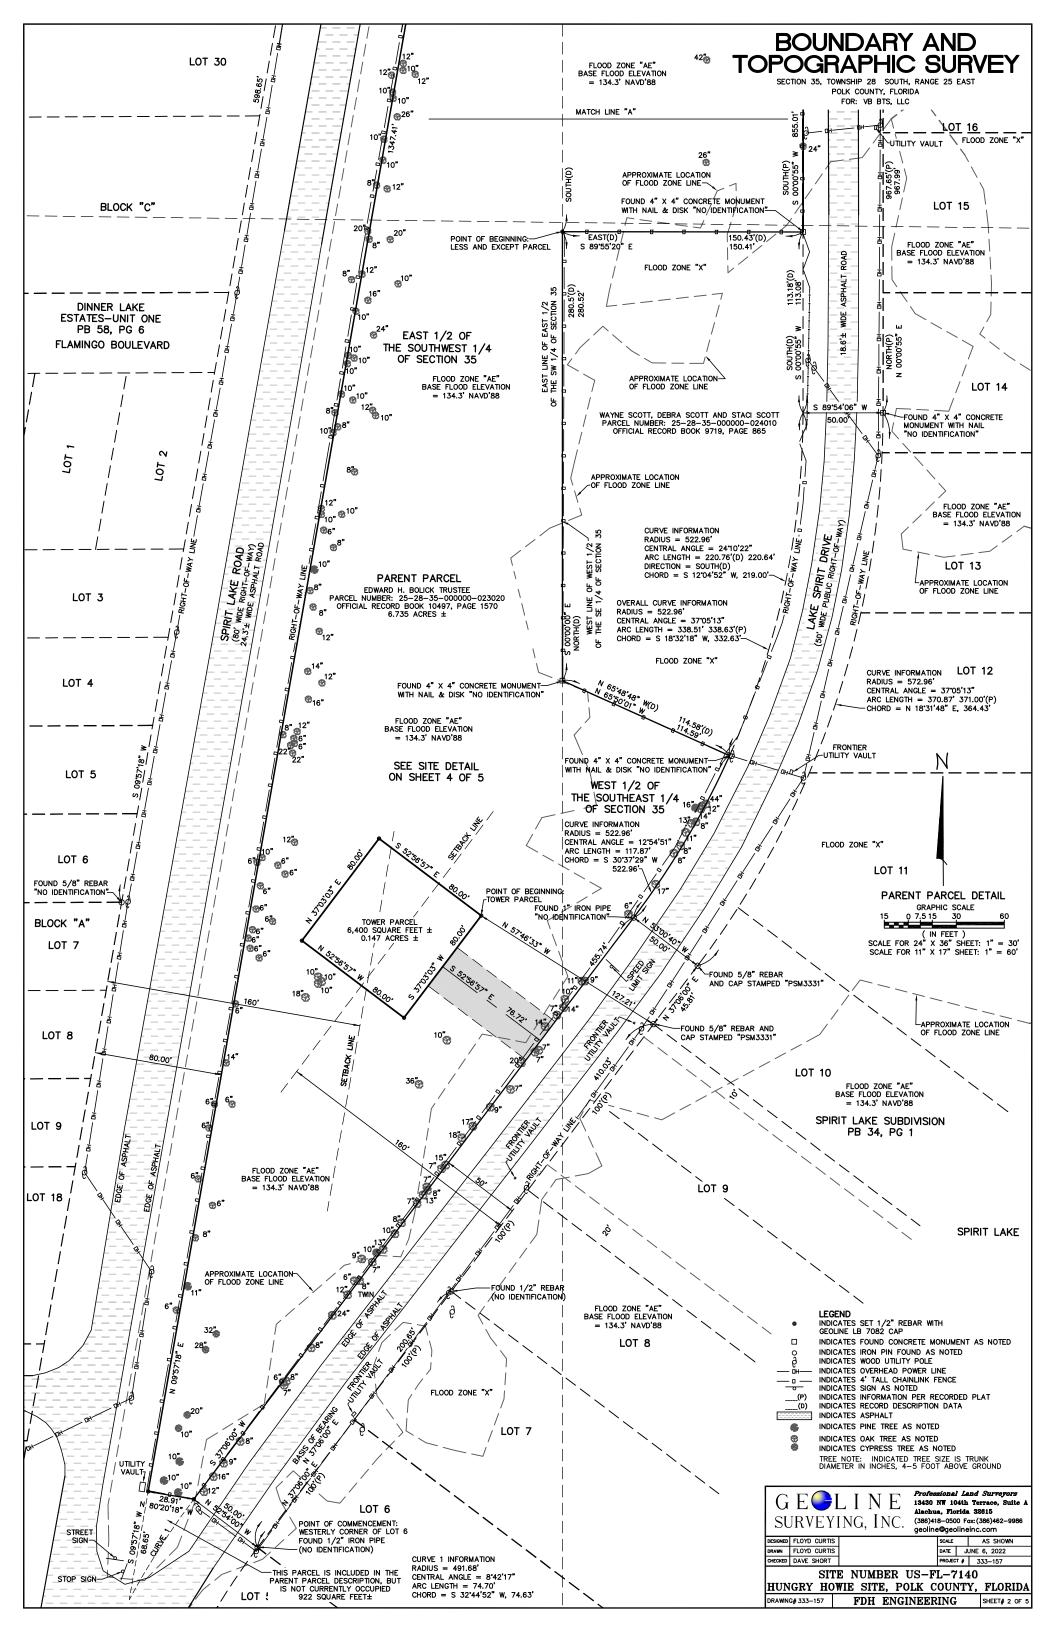

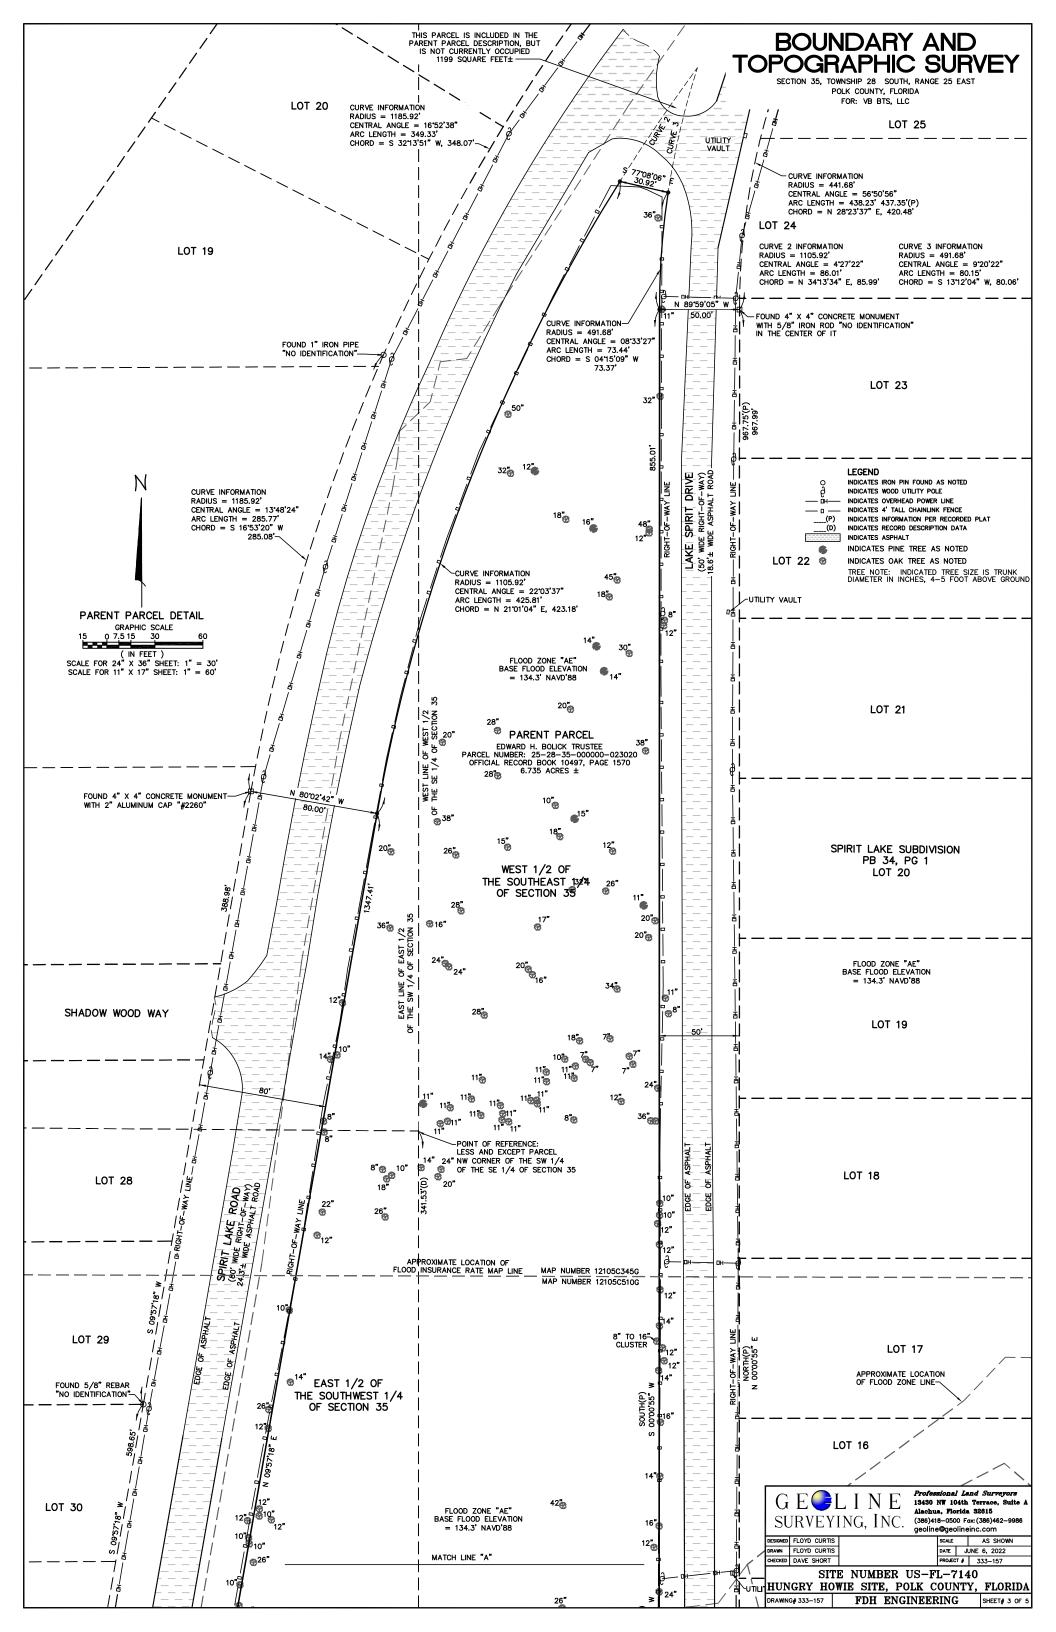


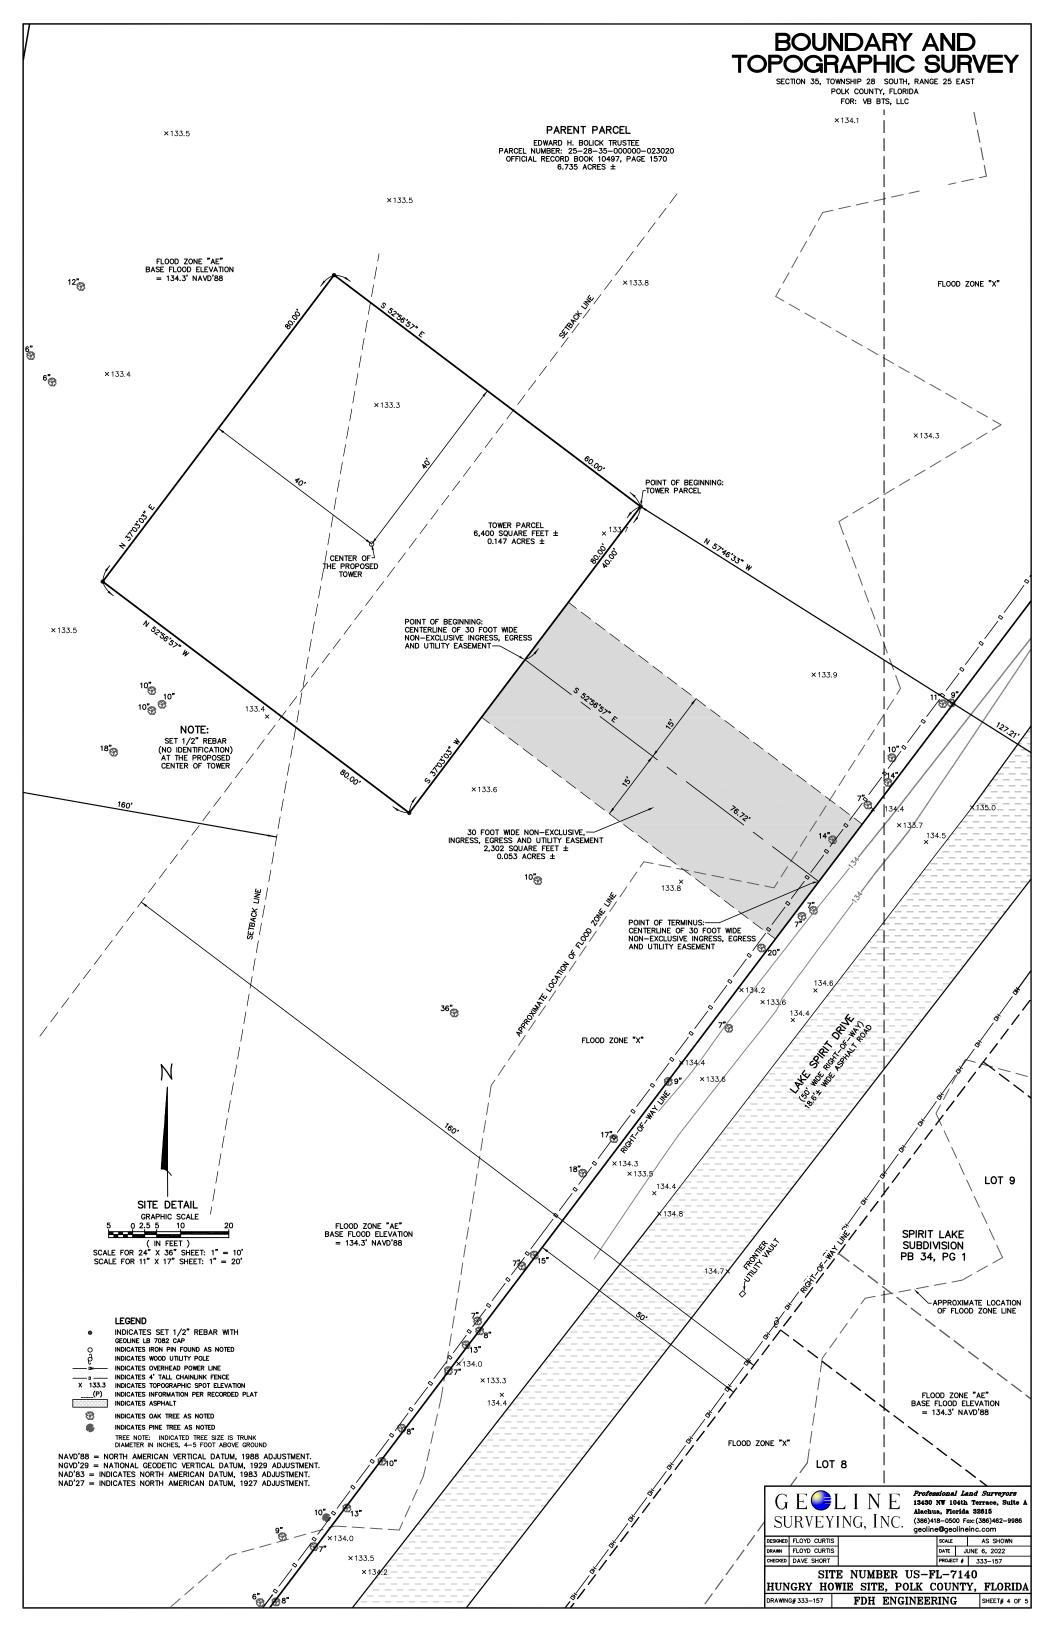

SECTION 35, TOWNSHIP 28 SOUTH, RANGE 25 EAST POLK COUNTY, FLORIDA FOR: VB BTS, LLC



VICINITY MAP NOT TO SCALE

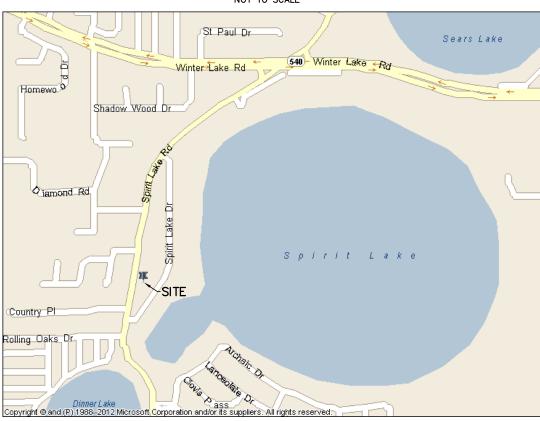

LOCATION MAP NOT TO SCALE

PROPERTY DESCRIPTIONS

N

PARENT PARCEL (OFFICIAL RECORD BOOK 10497, PAGE 1570)

THAT PART OF THE WEST 1/2 OF THE SE 1/4 OF SECTION 35, TOWNSHIP 28 SOUTH, RANGE 25 EAST, POLK COUNTY, FLORIDA, LYING WEST OF OLD SPIRIT LAKE ROAD AND SOUTH OF NEW SPIRIT LAKE ROAD AND THAT PART OF THE EAST 1/2 OF THE SW 1/4 LYING EAST OF NEW SPIRIT LAKE ROAD LESS AND EXCEPT BEGIN 341.53 FEET SOUTH OF THE NW CORNER OF THE SW 1/4 OF THE SE 1/4, RUN THENCE EAST 150.43 FEET, RUN THENCE SOUTH ALONG THE WEST BOUNDARY OF SPIRIT LAKE ROAD 113.18 FEET TO A POINT ON A CURVE THENCE RUN SOUTHWESTERLY ALONG SAID CURVE AN ARC DISTANCE OF 220.76 FEET, THENCE N 65'48'48" W 114.58 FEET, THENCE NORTH 280.5 FEET TO THE POINT OF BEGINNING.

PARCEL ID NUMBER: 252835-000000-023020

TOWER PARCEL

(PREPARED BY GEOLINE SURVEYING, INC.)

THAT PART OF THE "BOLICK" PARCEL, AS PER DESCRIPTION RECORDED IN OFFICIAL RECORD BOOK 10497, PAGE 1570 OF THE PUBLIC RECORDS OF POLK COUNTY, FLORIDA, LYING IN THE EAST 1/2 OF THE SOUTHWEST 1/4, AND THE WEST 1/2 OF THE SOUTHEAST 1/4, SECTION 35, TOWNSHIP 28 SOUTH, RANGE 25 EAST, SAID POLK COUNTY, BEING MORE PARTICULARLY DESCRIBED AS FOLLOWS:

COMMENCE AT THE WESTERLY CORNER OF LOT 6, SPIRIT LAKE SUBDIVISION, AS PER PLAT THEREOF RECORDED IN PLAT BOOK 34, PAGE 1 OF THE PUBLIC RECORDS OF POLK COUNTY, FLORIDA, SAID POINT BEING ON THE SOUTHEASTERLY RIGHT—OF—WAY LINE OF LAKE SPIRIT DRIVE (50 FOOT WIDE RIGHT—OF—WAY); THENCE NORTH 37'06'00" EAST ALONG SAID SOUTHEASTERLY RIGHT—OF—WAY LINE, ALONG THE NORTHWESTERLY LINE OF SAID LOT 6, AND ALONG THE NORTHWESTERLY LINE OF SAID LOT 6, AND ALONG THE NORTHWESTERLY LINE OF SAID SPIRIT LAKE SUBDIVISION FOR 410.03 FEET; THENCE NORTH 57'46'33" WEST FOR 127.21 FEET TO THE POINT OF BEGINNING; THENCE SOUTH 37'03'03" WEST FOR 80.00 FEET; THENCE NORTH 52'56'57" WEST FOR 80.00 FEET; THENCE NORTH 52'56'57" WEST FOR 80.00 FEET; THENCE SOUTH 52'56'57" EAST FOR 80.00 FEET TO SAID POINT OF BEGINNING.

CONTAINING 6,400 SQUARE FEET (0.147 ACRES), MORE OR LESS.

30 FOOT WIDE NON-EXCLUSIVE INGRESS, EGRESS AND UTILITY EASEMENT (PREPARED BY GEOLINE SURVEYING, INC.)

THAT PART OF THE "BOLICK" PARCEL, AS PER DESCRIPTION RECORDED IN OFFICIAL RECORD BOOK 10497, PAGE 1570 OF THE PUBLIC RECORDS OF POLK COUNTY, FLORIDA, LYING IN THE EAST 1/2 OF THE SOUTHWEST 1/4, AND THE WEST 1/2 OF THE SOUTHEAST 1/4, SECTION 35, TOWNSHIP 28 SOUTH, RANGE 25 EAST, SAID POLK COUNTY, LYING WITHIN 15 FEET OF BOTH SIDES OF A CENTERLINE BEING MORE PARTICULARLY DESCRIBED AS FOLLOWS:

COMMENCE AT THE WESTERLY CORNER OF LOT 6, SPIRIT LAKE SUBDIVISION, AS PER PLAT THEREOF RECORDED IN PLAT BOOK 34, PAGE 1 OF THE PUBLIC RECORDS OF POLK COUNTY, FLORIDA, SAID POINT BEING ON THE SOUTHEASTERLY RIGHT—OF—WAY LINE OF LAKE SPIRIT DRIVE (50 FOOT WIDE RIGHT—OF—WAY); THENCE NORTH 57'06'00' EAST ALONG SAID SOUTHEASTERLY RIGHT—OF—WAY); INE, ALONG THE NORTHWESTERLY LINE OF SAID LOT 6, AND ALONG THE NORTHWESTERLY LINE OF LOTS 7, 8, 9 AND 10 OF SAID SPIRIT LAKE SUBDIVISION FOR 410.03 FEET; THENCE NORTH 57'46'33" WEST FOR 127.21 FEET TO THE EASTERLY CORNER OF A 80 FOOT BY 80 FOOT TOWER PARCEL; THENCE SOUTH 37'03'03" WEST ALONG THE SOUTHEASTERLY LINE OF SAID TOWER PARCEL; FOR 40.00 FEET TO THE POINT OF BEGINNING OF THE CENTERLINE OF THE HEREIN DESCRIBED 30 FOOT WIDE NON—EXCLUSIVE INGRESS, EGRESS AND UTILITY EASEMENT; THENCE SOUTH 52'56'57" EAST FOR 76.72 FEET TO AN INTERSECTION WITH THE NORTHWESTERLY RIGHT—OF—WAY LINE OF SAID LAKE SPIRIT DRIVE AND THE POINT OF TERMINUS OF THE HEREIN DESCRIBED CENTERLINE.

CONTAINING 2,302 SQUARE FEET (0.053 ACRES), MORE OR LESS.

COMMITMENT FOR TITLE INSURANCE REVIEW NOTE

I HAVE REVIEWED THE COMMITMENT FOR TITLE INSURANCE ISSUED BY TOWER AGENCY, LLC, COMMITMENT NUMBER. VTB-129746-C, WITH AN EFFECTIVE DATE OF 03/16/2022, AND FIND AS FOLLOWS WITH RESPECT TO THE EXCEPTIONS LISTED ON SCHEDULE B-SECTION II OF SAID COMMITMENT:

1. ANY DEFECT, LIEN, ENCUMBRANCE, ADVERSE CLAIM, OR OTHER MATTER THAT APPEARS FOR THE FIRST TIME IN THE PUBLIC RECORDS OR IS CREATED, ATTACHES, OR IS DISCLOSED BETWEEN THE COMMITMENT DATE AND THE DATE ON WHICH ALL OF THE SCHEDULE B, PART I—REQUIREMENTS ARE MET. NOT THE TYPE TO BE DEPICTED HEREON.

2. RIGHTS OR CLAIMS OF PARTIES IN POSSESSION NOT SHOWN RECORDS. NOT THE TYPE TO BE DEPICTED HEREON.

3. EASEMENTS OR CLAIMS OF EASEMENTS NOT SHOWN BY THE PUBLIC RECORDS. NOT THE TYPE TO BE DEPICTED HEREON.

4. DISCREPANCIES, CONFLICTS IN BOUNDARY LINES, ENCROACHMENTS, OVERLAPS, VARIATIONS OR SHORTAGE IN AREA OR CONTENT, PARTY WALLS AND ANY OTHER MATTERS THAT WOULD BE DISCLOSED BY A CORRECT SURVEY AND/OR PHYSICAL INSPECTION OF THE LAND. AS DEPICTED HEREON.

5. ANY LIEN, OR RIGHT TO LIEN, FOR SERVICES, LABOR OR MATERIAL HERETOFORE OR HEREAFTER FURNISHED, IMPOSED BY LAW AND NOT SHOWN BY THE PUBLIC RECORD. NOT THE TYPE TO BE DEPICTED HEREON.

6. ANY WATER OR WELL RIGHTS, OR RIGHTS OR TITLE TO WATER OR CLAIMS THEREOF, IN, ON OR UNDER THE LAND. NOT THE TYPE TO BE DEPICTED HEREON.

7. UNPATENTED MINING CLAIMS; RESERVATIONS OR EXCEPTIONS IN PATENTS OR IN THE ACTS AUTHORIZING THE ISSUANCE OF SAID PATENTS. NOT THE TYPE TO BE DEPICTED HEREON.

8. ALL TAXES, ASSESSMENTS, LEVIES AND CHARGES WHICH CONSTITUTE LIENS OR ARE DUE OR PAYABLE INCLUDING UNREDEEMED TAX SALES. NOT THE TYPE TO BE DEPICTED HEREON.

9. RIGHTS OF FEE SIMPLE OWNERS IN AND TO THE SUBJECT PROPERTY. NOT THE TYPE TO BE DEPICTED HEREON.



Professional Land Surveyors 13430 NW 104th Terrace

FLOYD CURTIS CHECKED DAVE SHORT

AS SHOWN DATE JUNE 6, 2022 ROJECT # 333-157

SITE NUMBER US-FL-7140 HUNGRY HOWIE SITE, POLK COUNTY, FLORIDA

FDH ENGINEERING

GENERAL NOTES:

- EVERY EFFORT HAS BEEN MADE IN THE CONSTRUCTION DOCUMENTS TO PROVIDE A COMPLETE SCOPE OF WORK. MINOR DISCREPANCIES IN THE DRAWINGS AND/OR SPECIFICATIONS SHALL NOT EXCUSE CONTRACTORS FROM COMPLETING THE PROJECT AND IMPROVEMENTS IN ACCORDANCE WITH THE INTENT OF THESE DOCUMENTS.
- 2. BIDDING REQUIREMENTS
 - a. PRIOR TO THE SUBMISSION OF BIDS, VISIT THE JOB SITE TO BECOME FAMILIAR WITH ALL CONDITIONS AFFECTING THE PROPOSED PROJECT. VISIT THE SITE WITH THE CONSTRUCTION DOCUMENTS TO VERIFY FIELD DIMENSIONS AND CONDITIONS TO CONFIRM THAT THE PROJECT WILL BE ACCOMPLISHED AS SHOWN.
 - b. PROVIDE NOTIFICATION TO OWNER'S REPRESENTATIVE IN WRITING OF ANY CONFLICTS, ERRORS, OR OMISSIONS PRIOR TO SUBMISSION OF PRICE PROPOSAL. IN THE EVENT OF DISCREPANCIES, PRICE THE MORE COSTLY OR EXTENSIVE WORK, UNLESS DIRECTED OTHERWISE
 - c. WHEN TOWER IS OWNED BY A THIRD PARTY, CONTACT TOWER OWNER REPRESENTATIVE FOR PARTICIPATION IN BID WALK.
 - d. WHERE ANCHORING TO A CONCRETE ROOF SLAB, CONFIRM (PRIOR TO SUBMITTING BID) THE PRESENCE OF POST TENSION TENDONS. INCLUDE PROVISIONS FOR X-RAY PROCEDURES TO LOCATE THE TENDONS PRIOR TO CONSTRUCTION.
- 3. DRAWINGS ARE NOT TO BE SCALED. WRITTEN DIMENSIONS TAKE PRECEDENCE. CONSTRUCTION DOCUMENTS ARE INTENDED FOR DIAGRAMMATIC PURPOSES ONLY, UNO.
- 4. FURNISH ALL MATERIALS, EQUIPMENT, LABOR, AND ANY REQUIREMENTS NECESSARY TO COMPLETE PROJECT AS DESCRIBED IN THE CONSTRUCTION DOCUMENTS.
- 5. SUPERVISE AND DIRECT THE PROJECT DESCRIBED IN THE CONSTRUCTION DOCUMENTS, PROVIDE ALL CONSTRUCTION MEANS, METHODS, TECHNIQUES, SEQUENCES, AND PROCEDURES FOR COORDINATING ALL PORTIONS OF THE WORK UNDER THE CONTRACT.
- 6. ALL WORK PERFORMED ON THE PROJECT AND MATERIALS INSTALLED SHALL BE IN STRICT ACCORDANCE WITH ALL APPLICABLE CODES, REGULATIONS, AND ORDINANCES. GIVE ALL NOTICES AND COMPLY WITH ALL LAWS, ORDINANCES, RULES, REGULATIONS AND LAWFUL ORDERS OF ANY PUBLIC AUTHORITY, MUNICIPAL AND UTILITY COMPANY SPECIFICATIONS, AND LOCAL AND STATE JURISDICTIONAL CODES APPLICABLE TO THE WORK.
- 7. CONSTRUCTION COORDINATION REQUIREMENTS
 - a. NOTIFY OWNER'S REPRESENTATIVE OF ANY DISCREPANCIES PRIOR TO START OF WORK.
 - b. OBTAIN ALL PERMITS. SCHEDULE AND COORDINATE ALL INSPECTIONS.
 - c. PROVIDE, AT THE PROJECT SITE, A FULL, CURRENT SET OF CONSTRUCTION DOCUMENTS FOR USE BY ALL PERSONNEL INVOLVED WITH THE PROJECT.
 - d. RECEIVE WRITTEN AUTHORIZATION TO PROCEED WITH CONSTRUCTION PRIOR TO STARTING WORK ON ANY ITEM NOT CLEARLY DEFINED BY THE CONSTRUCTION DOCUMENTS.
 - e. PERFORM WORK DURING OWNER'S PREFERRED HOURS TO AVOID DISTURBING NORMAL BUSINESS.
 - PROVIDE FALL PROTECTION IN ACCORDANCE WITH FEDERAL, STATE, LOCAL, AND OWNER REQUIREMENTS.
 - g. IF FAA LIGHTING AND MARKING IS PRESENT ON SITE AND IS POWERED BY ELECTRICAL SERVICE THAT IS TO BE INTERRUPTED, MAINTAIN THE NECESSARY LIGHTS DURING CONSTRUCTION AND NOTIFY THE PROPER AUTHORITIES IN THE EVENT OF A DISRUPTION.
 - h. PROVIDE A PORTABLE FIRE EXTINGUISHER WITH A RATING OF NOT LESS THAN 2-A OR 2-A10BC WITHIN 75 FEET TRAVEL DISTANCE TO ALL PORTIONS OF PROJECT AREA DURING CONSTRUCTION.
 - i. STRUCTURAL COMPONENTS OF ADJACENT FACILITIES SHALL NOT BE ALTERED BY THIS CONSTRUCTION PROJECT, UNO. ENSURE THAT EXCAVATION DOES NOT AFFECT ADJACENT STRUCTURES
 - SEAL ALL PENETRATIONS THROUGH FIRE-RATED AREAS WITH U.L. LISTED OR FIRE MARSHALL-APPROVED MATERIALS, IF APPLICABLE.
 - k. BURIED UTILITIES MAY EXIST IN THE AREA AND UTILITY INFORMATION SHOWN MAY NOT BE COMPLETE. CONTACT THE UTILITY LOCATE SERVICE A MINIMUM OF 48 HOURS PRIOR TO CONSTRUCTION.
 - I. COORDINATE ALL POWER INSTALLATION WITH POWER COMPANY AS REQUIRED. REPORT POWER INSTALLATION COORDINATION SOLUTION(S) TO OWNER'S REPRESENTATIVE.
 - m. PROTECT EXISTING IMPROVEMENTS, EASEMENTS, PAVING, CURBING, ETC. DURING CONSTRUCTION. UPON COMPLETION OF WORK, REPAIR ANY DAMAGE THAT MAY HAVE OCCURRED DUE TO CONSTRUCTION ON OR ABOUT THE PROPERTY.
 - n. KEEP GENERAL WORK AREA CLEAN AND HAZARD FREE DURING CONSTRUCTION AND DISPOSE OF ALL DIRT, DEBRIS, AND RUBBISH. REMOVE EQUIPMENT NOT SPECIFIED AS REMAINING ON THE PROPERTY OR PREMISES. SITE SHALL BE LEFT IN CLEAN CONDITION AND FREE FROM PAINT SPOTS, DUST, OR SMUDGES OF ANY NATURE.
 - o. MAINTAIN THE INTEGRITY OF THE BUILDING ENVELOPE AND CONSTRUCT BARRIERS IN THE AREA OF WORK TO PREVENT DAMAGE FROM WEATHER AS WELL AS FROM CONSTRUCTION DUST AND DEBRIS.
- 8. INSTALL ALL EQUIPMENT AND MATERIALS ACCORDING TO MANUFACTURER'S SPECIFICATIONS, UNO, OR WHERE LOCAL CODES OR ORDINANCES DIRECT OTHERWISE.
- ANY SUBSTITUTIONS OF MATERIALS AND/OR EQUIPMENT, MUST BE APPROVED BY OWNER'S REPRESENTATIVE.

- 10. DOCUMENT ALL CHANGES MADE IN THE FIELD BY MARKING UP THE APPROVED CONSTRUCTION DRAWINGS AND SUBMITTING THE REDLINED SET TO OWNER'S REPRESENTATIVE UPON COMPLETION. DOCUMENT ALL WORK PERFORMED WITH PHOTOGRAPHS TO BE SUBMITTED WITH REDLINED CONSTRUCTION DRAWINGS.
- 11. PROVIDE SUPPORTS FOR CABLES TO THE ELEVATION OF ALL INITIAL AND FUTURE ANTENNAS IN ACCORDANCE WITH ALL MANUFACTURER'S REQUIREMENTS.
- 12. A STRUCTURAL ANALYSIS AND A MOUNT ANALYSIS (IF REQUIRED) TO DETERMINE THE STRUCTURAL CAPACITY TO SUPPORT THIS PROPOSED EQUIPMENT WAS PERFORMED OUTSIDE THE SCOPE OF THIS PROJECT.
- 13. CONFIRM THAT THE REQUIREMENTS OF THE STRUCTURAL ANALYSIS, MOUNT ANALYSIS AND ANY ASSOCIATED MODIFICATIONS HAVE BEEN FOLLOWED AND COMPLETED AS REQUIRED TO SUPPORT THE EQUIPMENT ASSOCIATED WITH THIS PROJECT.

SPECIAL INSPECTIONS:

- WHEN REQUIRED, PROVIDE SPECIAL INSPECTIONS PERFORMED BY AN INDEPENDENT INSPECTOR, APPROVED BY OWNER'S REPRESENTATIVE AND THE LOCAL JURISDICTION.
- THE SPECIAL INSPECTOR SHALL PROVIDE A COPY OF THE REPORT TO THE OWNER'S REPRESENTATIVE, STRUCTURAL ENGINEER, CONTRACTOR, AND BUILDING OFFICIAL.

POLK COUNTY LAND DEVELOPMENT DIVISION STANDARD NOTES

- TRAFFIC SIGNS AND PAVEMENT MARKINGS SHALL BE INSTALLED PRIOR TO OPENING A NEW OR MODIFIED ROAD
- ALL CONSTRUCTION SHALL CONFORM TO THE REQUIREMENTS OF APPENDIX A OF THE POLK COUNTY LAND DEVELOPMENT CODE AND THE POLK COUNTY UTILITIES CODE, AS APPLICABLE.
- S. CHANGES FROM PLANS OR SPECIFICATIONS SUBSTANTIALLY AFFECTING CONFORMANCE TO STANDARDS OR PERFORMANCE OF SYSTEMS MUST BE SUBMITTED IN A WRITTEN REQUEST BY THE ENGINEER OF RECORD AND RECEIVE WRITTEN APPROVAL BY THE COUNTY ENGINEER PRIOR TO THE IMPLEMENTATION OF SUCH CHANGES, UNLESS OTHERWISE PROVIDED FOR IN THE POLK COUNTY LAND DEVELOPMENT CODE OR THE POLK COUNTY UTILITIES CODE. MAJOR MODIFICATIONS MAY REQUIRE AN APPROVAL BY THE DEVELOPMENT REVIEW COMMITTEE. IN SUCH CASES, THE APPLICANT SHALL SUBMIT THE APPROPRIATE APPLICATION AND FEES FOR A NEW REVIEW AT THE LEVEL OF THE ORIGINAL APPROVAL, OR LEVEL 2, WHICHEVER IS GREATER.
- 4. THE CONTRACTOR SHALL NOTIFY POLK COUNTY INSPECTIONS STAFF (863) 534-6449, AT LEAST FIVE (5) WORKING DAYS PRIOR TO COMMENCEMENT OF CONSTRUCTION AND PRIOR TO ANY ACTIVITY REQUIRING INSPECTION. INCLUDING SITE PAVING.
- 5. TO SCHEDULE THE REQUIRED PRE-CONSTRUCTION MEETING, THE ENGINEER OF RECORD SHALL CONTACT THE POLK COUNTY LAND DEVELOPMENT DIVISION, OFFICE OF THE COUNTY ENGINEER AT (863) 534-6449.
- 6. AT THE COMPLETION OF CONSTRUCTION, AND PRIOR TO BENEFICIAL USE OF ANY FACILITY OR SYSTEM, AS-BUILT RECORD DRAWINGS SHALL BE SUBMITTED AND APPROVED IN ACCORDANCE WITH POLK COUNTY UTILITIES CODE, CHAPTER 2, PART 3.01 AND THE POLK COUNTY LAND DEVELOPMENT CODE, APPENDIX A, SECTION A406.C.
- MOT FOR THE PROJECT WILL BE IN ACCORDANCE WITH THE CURRENT FDOT TRAFFIC CONTROL REQUIREMENTS THROUGH WORK ZONES, SECTION 102-600 SERIES, OF THE FDOT STANDARD PLANS.
- 8. THE ASPHALT PAVEMENT WILL EXTEND ½ INCH ABOVE THE ROAD SIDE EDGE FOR ALL CURB AND GUTTER CONSTRUCTED ON PUBLIC OR PRIVATE ROADS.
- POLK COUNTY IS NOT RESPONSIBLE FOR DESIGN AND/OR PLAN ERRORS. ALL CONSTRUCTION WITHIN POLK COUNTY RW SHALL BE IN ACCORDANCE WITH POLK COUNTY AND FDOT STANDARDS AND SPECIFICATIONS. ALL CONSTRUCTION SHALL CONFORM TO THE REQUIREMENTS OF APPENDIX A OF THE POLK COUNTY LAND DEVELOPMENT CODE AND THE POLK COUNTY UTILITIES CODE, AS APPLICABLE

ABBREVIATIONS

A/C	AIR CONDITIONING		LBS	POUNDS
AFF	ABOVE FINISHED FLOOR		LTE	LONG TERM EVOLUTION
AGL	ABOVE GROUND LEVEL,		MAX	MAXIMUM
	ABOVE GRADE LEVEL	MECH	MECHA	NICAL
AWS	ADVANCED WIRELESS SERVICE		MTL	METAL
BBU	BATTERY BACKUP UNIT		MFR	MANUFACTURE
BLDG	BUILDING		MGR	MANAGER
BLK	BLOCKING		MIN	MINIMUM
CLG	CEILING		MISC	MISCELLANEOUS
CLR	CLEAR		NA	NOT APPLICABLE
CONC	CONCRETE		NIC	NOT IN CONTRACT
CONT	CONTINUOUS		NO	NUMBER
D	DEPTH		NTS	NOT TO SCALE
DBL	DOUBLE		ОС	ON CENTER
DEG	DEGREE		OD	OUTSIDE DIAMETER
Ø, DIA	DIAMETER		PCS	PERSONAL COMMUNICATION
DIAG	DIAGONAL			SERVICE
DN	DOWN		PDU	POWER DISTRIBUTION UNIT
DET	DETAIL		PROJ	PROJECT
DWG	DRAWING		PROP	PROPERTY
E	EXISTING		PT	PRESSURE TREATED
EA	EACH		PVC	POLYVINYL CHLORIDE
ELEV, EL	ELEVATION		REQ	REQUIRED
ELEC	ELECTRICAL		RF	RADIO FREQUENCY
EQ	EQUAL		RM	ROOM
EQUIP	EQUIPMENT		RO	ROUGH OPENING
EXT	EXTERIOR		RRH	REMOTE RADIO HEAD
FIF	FIBER INTERFACE FRAME,		SHT	SHEET
	FACILITY INTERFACE FRAME		SIM	SIMILAR
FIN	FINISH		SPEC	SPECIFICATION
FLUOR	FLUORESCENT		SF	SQUARE FOOT
FLR	FLOOR		SS	STAINLESS STEEL
FT	FOOT, FEET		STL	STEEL
GA	GAUGE		SUSP	SUSPENDED
GALV	GALVANIZED		TMA	TOWER MOUNTED AMPLIFIER
GC	GENERAL CONTRACTOR		TND	TINNED
GRND	GROUND		TYP	TYPICAL
GSM	GLOBAL SYSTEM MOBILE		UMTS	UNIVERSAL MOBILE
GYP	GYPSUM BOARD			TELECOMMUNICATION SERVICE
HORZ OTHERWISE	HORIZONTAL		UNO	UNLESS NOTED
HR	HOUR		VERT	VERTICAL
HT	HEIGHT		W/	WITH
ID	INSIDE DIAMETER		W/O	WITHOUT
IN	INCH, INCHES		wcs	WIRELESS COMMUNICATION
INSUL	INSULATION			SERVICE
INT	INTERIOR		WP	WATER PROOF

LENGTH

DLC II II

DID 11, LLU
750 PARK OF COMMERCE DR, SUITE 200

BOCA RATON, FL 33487






TAMPA FL 33634

ENGINEERING INNOVATION
FDH INFRASTRUCTURE SERVICES, LLC

THE INFORMATION CONTAINED IN THIS SET OF DOCUMENTS IS PROPRIETARY BY NATURE. REPRODUCTION OR CAUSING TO BE REPRODUCED THE WHOLE OR ANY PART OF THESE DRAWINGS WITHOUT THE PERMISSION OF FOH IS PROHIBITED.

SUBMITTALS							
REV	DATE	DESCRIPTION	BY	CHK'E			
0	03/17/2023	CONSTRUCTION	ZK	JRB			

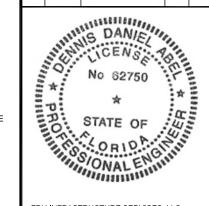

FDH INFRASTRUCTURE SERVICES, LLC DENNIS D. ABEL, PE STATE LICENNSE NO. 62750

FDH JOB NUMBER:

PR-008353

SITE ID: US-FL-7140

SITE NAME:

HUNGRY HOWIE

T-MOBILE SITE ID: A2B2227A

, LDZZZI,

252835000000023020

ADDRESS:

3024 SPIRIT LAKE DRIVE WINTER HAVEN, FL 33880

SHEET TITLE:

GENERAL NOTES

SHEET NUMBER:

SITE NOTES:

- CLEAR AND GRUB SITE OF ALL VEGETATION, PAVING, GRAVEL BASE AND OTHER DEBRIS NOT TO REMAIN. SUBGRADES ARE TO BE SET PRIOR TO LANDSCAPE INSTALLATION.
- PROVIDE ELEVATION OF SUBGRADE WITHIN 0.10 FOOT OF ELEVATIONS SHOWN ON PLAN MINUS DEPTH OF TOPSOIL, FILL, AND MULCH.
- ROUGH GRADE ALL AREAS WITHIN 1 FOOT OF ELEVATIONS INDICATED BEFORE PLANTING. PROVIDE POSITIVE DRAINAGE AWAY FROM EQUIPMENT SLABS, BUILDINGS AND THROUGH ALL PLANTER AREAS TO AVOID LOW SPOTS AND STANDING WATER.
- REWORK (DRY, SCARIFY, ETC.) ALL MATERIAL NOT SUITABLE FOR SUB GRADE IN ITS PRESENT STATE. AFTER REWORKING, IF THE MATERIAL REMAINS UNSUITABLE, UNDERCUT AND REPLACE WITH SUITABLE MATERIAL AT CONTRACTOR'S EXPENSE. ALL SUB GRADES AND AGGREAGATE BASE 2. BASE STRUCTURAL STEEL DESIGN, FABRICATION AND ERECTION (INCLUDING FIELD WELDING, HIGH COURSES SHALL BE PROOF ROLLED WITH A FULLY LOADED TANDEM DUMP TRUCK, AND ANY SOFT SPOTS SHALL BE REWORKED OR REPLACED UNTIL PASSING PROOF ROLL.
- BI FND NEW GRADES NATURALLY INTO EXISTING GRADES.
- MAINTAIN POSITIVE DRAINAGE ON THE SITE AT ALL TIMES, INCLUDING KEEPING ALL EXISTING AND NEW DITCHES, PIPES AND OTHER DRAINAGE STRUCTURES FREE FROM OBSTRUCTION, ANY DAMAGE RESULTING FROM FAILURE TO COMPLY SHALL BE REMEDIED BY CONTRACTOR
- IF REQUIRED, MAINTAIN CONTINUOUS EROSION CONTROL ON THE DOWNSTREAM SIDE OF THE SITE
- IN LANDSCAPE AREAS, FINISH GRADES ARE TO FOLLOW THE GRADES AND EDGE DETAILS INDICATED AND BE MOUNDED 6 INCHES IN THE CENTER OF THE BED ABOVE THE EDGE OF THE LANDSCAPE AREA
- DO NOT PLACE FILL OR EMBANKMENT MATERIAL ON FROZEN GROUND. DO NOT PLACE FROZEN MATERIALS, SNOW OR ICE IN ANY FILL OR EMBANKMENT
- 10. NOTIFY OWNER'S REPRESENTATIVE IF MODIFICATIONS TO THE PROPOSED GRADING SEEM NECESSARY AND OBTAIN APPROVAL PRIOR TO START OF WORK.
- 11. FOOTINGS SHALL BEAR ON FIRM, NATURAL, UNDISTURBED SOIL, OR ON ENGINEERED FILL (COMPACTED TO 95% ASTM D698), ENSURE THAT EXCAVATIONS ARE FREE OF ORGANIC MATERIAL. DEBRIS, OR OTHER FOREIGN MATERIAL. NOTIFY OWNER'S REPRESENTATIVE IF ANY UNUSUAL CONDITIONS ARE ENCOUNTERED.
- 12. FILL AND SLAB BASE MATERIAL SHALL BE 3/4" MINUS CRUSHED ROCK PLACED IN 8" (MAXIMUM) LOOSE LIFTS AND COMPACTED TO 98% ASTM D698.

CONCRETE NOTES:

CONCRETE AND REINFORCING SHALL CONFORM TO THE FOLLOWING REQUIREMENTS:

CONCRETE CONSTRUCTION ACI 318

CEMENT ASTM C150, PORTLAND CEMENT TYPE II, UNO

ASTM A615 (INCLUDING SUPPLEMENT S1), GRADE 60, REINFORCING STEEL

fv=60 Ksi, UNO

WELDED WIRE FARRIC ASTM A185

SPIRAL REINFORCEMENT ASTM A615, GRADE 60, fy=60 KSI

ANCHOR BOLTS ASTM A307 GRADE 60 REBAR WELDING ASTM A706

NOTES: ANY BARS SO NOTED ON THE DRAWINGS SHALL BE GRADE 60, fy=60 KSI, REINFORCING COMPLYING WITH ASTM A615(S1) MAY BE WELDED ONLY IF MATERIAL PROPERTY REPORTS INDICATING CONFORMANCE WITH WELDING PROCEDURES SPECIFIED IN A.W.S. D14 ARE

2. CONCRETE PROTECTION (COVER) FOR REINFORCING STEEL SHALL BE AS FOLLOWS:

FOOTINGS AND OTHER UNFORMED SURFACES, EARTH FACE 3" FORMED SURFACES EXPOSED TO EARTH OR WEATHER 2" (> #6 BARS) FORMED SURFACES EXPOSED TO EARTH OR WEATHER (≤ #5 BARS) 1-1/2' SLABS AND WALLS (INTERIOR FACE)

- AIR ENTRAIN ALL CONCRETE WITH SURFACES EXPOSED TO WEATHER WITH AN AIR-ENTRAINING AGENT CONFORMING TO ASTM C260, C494, C618, C989 AND C1017, AIR ENTRAIN CONCRETE EXPOSED TO FREEZING AND THAWING WHILE MOIST IN ACCORDANCE WITH ACI 318, SECTION 4.4.1.
- DETAIL REINFORCING STEEL (INCLUDING HOOKS AND BENDS) IN ACCORDANCE WITH ACI 315 AND 318. LAP ALL CONTINUOUS REINFORCEMENT AT LEAST 30 BAR DIAMETERS OR A MINIMUM OF 2'-0". PROVIDE CORNER BARS AT ALL WALL AND FOOTING INTERSECTIONS. LAP CORNER BARS AT LEAST 30 BAR DIAMETERS OR A MINIMUM OF 2'-0". LAP ADJACENT MATS OF WELDED WIRE FABRIC A MINIMUM OF 8" AT SIDES AND ENDS.
- 5. PERFORM WELDING OF GRADE 60 REINFORCING BARS (IF REQUIRED) USING LOW HYDROGEN FLECTRODES PERFORM WELDING OF GRADE 40 REINFORCING BARS (IF REQUIRED) USING E70 XX ELECTRODES, DO NOT WELD WITHIN 4" OF COLD BENDS IN REINFORCING STEEL.
- DO NOT FIELD BEND REINFORCING PARTIALLY EMBEDDED IN CONCRETE LINLESS SPECIFICALLY SO DETAILED OR APPROVED BY THE ENGINEER.
- SUPPORT BARS ON CHAIRS OR DOBIE BRICKS
- FURNISH NON-SHRINK GROUT BY AN APPROVED MANUFACTURER. MIX AND PLACE IN STRICT ACCORDANCE WITH THE MANUFACTURER'S PUBLISHED RECOMMENDATIONS. GROUT STRENGTH SHALL BE AT LEAST EQUAL TO THE MATERIAL ON WHICH IT IS PLACED (3 KSI, MINIMUM).
- ALL EXPANSION ANCHORS TO BE HILTI BRAND, UNO. TEST ADHESIVE ANCHORS TO CONFIRM CAPACITY UNLESS WAIVED BY ENGINEER AND LOCAL JURISDICTION

STRUCTURAL STEEL NOTES:

1. STRUCTURAL STEEL SHALL CONFORM TO THE FOLLOWING REQUIREMENTS:

WIDE FLANGE SHAPES ASTM A992, GRADE 50 SHAPES, PLATES, ANGLES, & RODS ASTM A36, Fy 36 KSI SPECIAL SHAPES AND PLATES ASTM A572. Fv 50 KSI PIPE COLUMNS ASTM A53. Fv 35 KSI STRUCTURAL TUBING ASTM A500, Fy 46KSI ANCHOR BOLTS ASTM A307 CONNECTION BOLTS ASTM A325 TWIST-OFF

- STRENGTH FIELD BOLTING, EXPANSION BOLTS, AND THREADED EXPANSION ANCHORS) ON THE AISC "SPECIFICATION FOR THE DESIGN, FABRICATION, AND ERECTION OF STRUCTURAL STEEL FOR BUILDINGS" LATEST EDITION.
- 3. HOT DIP GALVANIZE AFTER FABRICATION PER A123/A123M-00 ALL STEEL EXPOSED TO WEATHER AND WHERE NOTED.
- 4. CONFORM TO ALL AISC AND AWS STANDARDS FOR WELDING, PERFORM WELDING BY ANSI/AWS D1.1 CERTIFIED WELDERS USING E70 XX ELECTRODES. USE ONLY PRE-QUALIFIED WELDS AS DEFINED BY
- 5. PROVIDE COLD-FORMED STEEL FRAMING MEMBERS OF THE SHAPE, SIZE, AND GAGE SHOWN ON THE PLANS. PROVIDE MINIMUM SECTION PROPERTIES INDICATED. ALL COLD-FORMED STEEL FRAMING SHALL CONFORM TO THE AISL "SPECIFICATION FOR THE DESIGN OF COLD-FORMED STEEL STRUCTURAL MEMBERS."
- 6. FOR BOLTED CONNECTIONS, USE 3/4" DIA., BEARING-TYPE, A325 BOLTS WITH A MINIMUM OF TWO BOLTS, UNO.
- 7. FOR NON-STRUCTURAL CONNECTIONS FOR STEEL GRATING, USE 5/8" DIA, A307 BOLTS, UNO.
- 8. PREPARE AND PAINT IN ACCORDANCE WITH THE PAINT MANUFACTURERS WRITTEN INSTRUCTIONS,
- 9. TOUCH UP ALL FIELD DRILLING, WELDING AND CUT SURFACES WITH 2 COATS OF GALVACON (ZINC RICH PAINT) OR APPROVED EQUAL.

TOWER LIGHTING NOTE:

COMMUNICATION TOWERS SHALL NOT BE ARTIFICIALLY LIGHTED UNLESS REQUIRED BY THE FAA OR ANY OTHER AUTHORITY WITH JURISDICTION, IF LIGHTING IS REQUIRED, STROBE LIGHTING SHALL BE UTILIZED DURING DAYLIGHT HOURS ONLY AND RED LIGHTING SHALL BE UTILIZED AT NIGHT UNLESS ANOTHER FORM OF LIGHTING IS REQUIRED BY THE FAA OR ANY OTHER AUTHORITY WITH JURISDICTION.

ABANDONMENT NOTE:

ABANDONED COMMUNICATION TOWERS SHALL BE REMOVED WITHIN 30 DAYS OF ABANDONMENT. THE OWNER OF AN ABANDONED TOWER, AS WELL AS THE OWNER OF THE REAL PROPERTY UPON WHICH THE TOWER IS SITUATED, SHALL BE JOINTLY AND SEVERALLY RESPONSIBLE FOR ITS REMOVAL, A COMMUNICATION TOWER SHALL BE CONSIDERED ABANDONED IF NO LICENSED OPERATOR HAS HAD AN ANTENNA IN USE ON THE STRUCTURE FOR A PERIOD OF 365 CONSECUTIVE DAYS.

SIGNAGE NOTE:

NO COMMERCIAL SIGNAGE OR ADVERTISING SHALL BE PLACED ON COMMUNICATION TOWERS. HOWEVER SIGNS PERTAINING TO TRESPASSING MAY BE POSTED ON COMMUNICATION TOWERS AND EMERGENCY PHONE NUMBERS SHALL BE POSTED IN A CONSPICUOUS LOCATION ON THE SECURITY FENCING REQUIRED.

FINISH NOTE:

WITH THE EXCEPTION OF CONCRETE COMMUNICATION TOWERS, ALL COMMUNICATION TOWERS SHALL HAVE EITHER A GALVANIZED STEEL FINISH OR, SUBJECT TO ANY APPLICABLE STANDARDS OF THE FAA, BE PAINTED A NEUTRAL COLOR SO AS TO REDUCE VISUAL OBTRUSIVENESS.

FDOT NOTE:

ALL DRIVEWAY IMPROVEMENTS WILL COMPLY WITH APPLICABLE FDOT INDEX FOR DESIGN, MATERIAL QUALITY, AND WORKMANSHIP

ANNUAL REPORT:

EACH OWNER OR OPERATOR OF A COMMUNICATION TOWER LOCATED IN LININCORPORATED POLIC COUNTY SHALL SUBMIT AN ANNUAL REPORT TO THE LAND DEVELOPMENT DIVISION ON FORMS TO BE PROVIDED BY THE LAND DEVELOPMENT DIVISION OR OTHER FORM CONTAINING THE SAME INFORMATION THAT MAY BE REQUIRED BY ANY OTHER REGULATORY AGENCY NO LATER THAN JANUARY 31 OF EACH YEAR. THE ANNUAL REPORT SHALL CONTAIN THE FOLLOWING INFORMATION:

- i. THE NAME OF THE OWNER AND OPERATOR OF THE COMMUNICATION TOWER;
- ii. THE NAME OF THE OWNER OF THE SITE UPON WHICH THE COMMUNICATION TOWER IS LOCATED
- iii. THE NAMES OF ALL SERVICE PROVIDERS WITH ANTENNAS ON THE COMMUNICATION TOWER;
- iv. THE CURRENT HEIGHT OF THE COMMUNICATION TOWER:
- v. AN AFFIDAVIT INDICATING NON-ABANDONMENT OF THE COMMUNICATION TOWER: AND
- vi. SUCH OTHER INFORMATION AS INDICATED ON THE FORM PROVIDED BY THE LAND DEVELOPMENT DIVISION.

CARRIER EQUIPMENT PLATFORM:

SEE PLATFORM DESIGN SPECIFIC NOTES ON SN-1 AND SN-2.



750 PARK OF COMMERCE DR, SUITE 200 BOCA RATON, FL 33487





TAMPA FL 33634

ENGINEERING INNOVATION FDH INFRASTRUCTURE SERVICES, LLC

THE INFORMATION CONTAINED IN THIS SET OF DOCUMENTS IS PROPRIETARY BY NATURE REPRODUCTION OR CAUSING TO BE REPRODUCED THE WHOLE OR ANY PART OF THESE DRAWINGS VITHOUT THE PERMISSION OF FDH IS PROHIBITED

SUBMITTALS						
REV	DATE	DESCRIPTION	BY	CHK'D		
0	03/17/2023	CONSTRUCTION	ZK	JRB		
			-			
			-			



FDH INFRASTRUCTURE SERVICES, LLC DENNIS D. ABEL, PE STATE LICENNSE NO. 62750

FDH JOB NUMBER:

PR-008353

SITE ID: US-FL-7140

SITE NAME:

HUNGRY HOWIE

T-MOBILE SITE ID: A2B2227A

252835000000023020

ADDRESS:

3024 SPIRIT LAKE DRIVE WINTER HAVEN, FL 33880

SHEET TITLE:

GENERAL NOTES

SHEET NUMBER:

ELECTRICAL NOTES:

GENERAL

GENERAL CONDITIONS:

- A. CONTRACTOR SHALL INSPECT THE EXISTING SITE CONDITIONS PRIOR TO SUBMITTING BID. ANY QUESTIONS ARISING DURING THE BID PERIOD IN REGARD TO THE CONTRACTORS FUNCTIONS, THE SCOPE OF WORK, OR ANY OTHER ISSUE RELATED TO THIS PROJECT SHALL BE ISSUED TO CONSTRUCTION MANAGER IN WRITING FOR CLARIFICATION PRIOR TO SUBMITTAL OF BID AND CONTRACT AWARD.
- B. THE CONTRACTOR SHALL OBTAIN PERMITS, LICENSES, MAKE ALL DEPOSITS, AND PAY ALL FEES REQUIRED FOR THE CONSTRUCTION OF WORK UNDER THIS SECTION.
- C. DRAWINGS SHOW THE GENERAL ARRANGEMENT OF ALL SYSTEMS AND COMPONENTS COVERED UNDER THIS SECTION. THE CONTRACTOR SHALL FIELD VERIFY ALL DIMENSIONS. DRAWINGS SHALL NOT BE SCALED TO DETERMINE DIMENSIONS.

LAWS, REGULATIONS, ORDINANCES, STATUTES AND CODES:

A. ALL WORK SHALL BE INSTALLED IN ACCORDANCE WITH THE LATEST EDITION OF THE NATIONAL ELECTRICAL CODE (NEC), AND ALL APPLICABLE LOCAL LAWS, REGULATIONS, ORDINANCES, STATUTES AND CODES, CONDUIT BENDS SHALL BE THE RADIUS BEND FOR THE TRADE SIZE OF CONDUIT IN COMPLIANCE WITH THE LATEST EDITIONS OF NEC

REFERENCES:

- A. THE PUBLICATIONS LISTED BELOW ARE PART OF THIS SPECIFICATION. EACH PUBLICATION SHALL BE THE LATEST REVISION AND ADDENDUM IN EFFECT ON THE DATE. THIS SPECIFICATION IS ISSUED FOR CONSTRUCTION UNLESS OTHERWISE NOTED. EXCEPT AS MODIFIED BY THE REQUIREMENT SPECIFIED HEREIN OR THE DETAILS OF THE DRAWINGS, WORK INCLUDED IN THIS SPECIFICATION SHALL CONFORM TO THE APPLICABLE PROVISION OF THESE PUBLICATIONS.
 - 1. ANSI/IEEE (AMERICAN NATIONAL STANDARDS INSTITUTE)
 - ASTM (AMERICAN SOCIETY FOR TESTING AND MATERIALS)
 - ICEA (INSULATED CABLE ENGINEERS ASSOCIATION)
 - 4. NEMA (NATIONAL ELECTRICAL MANUFACTURER'S ASSOCIATION)
 - 5. NFPA (NATIONAL FIRE PROTECTION ASSOCIATION)
 - 6. OSHA (OCCUPATIONAL SAFETY AND HEALTH ADMINISTRATION)
 - 7. UL (UNDERWRITERS LABORATORIES. INC.)
 - 8. AT&T GROUNDING AND BONDING STANDARDS, LATEST EDITION, AND COMPLY WITH AT&T GROUNDING CHECKLIST, LATEST VERSION

SCOPE OF WORK

- A. WORK UNDER THIS SECTION SHALL CONSIST OF FURNISHING ALL LABOR, MATERIAL, AND ASSOCIATED SERVICES REQUIRED TO COMPLETE REQUIRED CONSTRUCTION AND BE OPERATIONAL.
- B. ALL ELECTRICAL EQUIPMENT UNDER THIS CONTRACT SHALL BE PROPERLY TESTED, ADJUSTED, AND ALIGNED BY THE CONTRACTOR
- C. THE CONTRACTOR SHALL BE RESPONSIBLE FOR ALL EXCAVATING, DRAINING OF TRENCHES, BACKFILLING, AND REMOVAL OF EXCESS DIRT.
- D. THE CONTRACTOR SHALL PREPARE A COMPLETE SET OF AS-BUILT DRAWINGS, DOCUMENT ALL WIRING EQUIPMENT CONDITIONS, AND CHANGES WHILE COMPLETING THIS CONTRACT, THE AS-BUILT DRAWINGS SHALL BE SUBMITTED AT COMPLETION OF THE PROJECT

PRODUCTS

GENERAL:

- A. ALL MATERIALS AND EQUIPMENT SHALL BE UL LISTED, NEW, AND FREE FROM DEFECTS.
- B. ALL ITEMS OF MATERIALS AND EQUIPMENT SHALL BE ACCEPTABLE TO THE AUTHORITY HAVING JURISDICTION AS SUITABLE FOR THE USE INTENDED.
- C. ALL EQUIPMENT SHALL BEAR THE UNDERWRITERS LABORATORIES LABEL OF APPROVAL, AND SHALL CONFORM TO REQUIREMENT OF THE NATIONAL ELECTRICAL CODE.
- D. ALL OVERCURRENT DEVICES SHALL HAVE AN INTERRUPTING CURRENT RATING EQUAL TO OR GREATER THAN THE SHORT CIRCUIT CURRENT AVAILABLE, 10,000 AIC MINIMUM. VERIFY AVAILABLE SHORT CIRCUIT CURRENT DOES NOT EXCEED THE RATING OF ELECTRICAL EQUIPMENT.

MATERIALS AND EQUIPMENT:

- A. CONDUIT
 - 1. RIGID METAL CONDUIT (RMC) SHALL BE HOT-DIPPED GALVANIZED INSIDE AND OUTSIDE INCLUDING ENDS AND THREADS AND ENAMELED OR LACQUERED INSIDE IN ADDITION TO GALVANIZING.
 - 2. LIQUID TIGHT FLEXIBLE METAL CONDUIT (LFMC) SHALL BE UL LISTED.
 - 3. CONDUIT CLAMPS, STRAPS AND SUPPORTS SHALL BE STEEL OR MALLEABLE IRON. ALL FITTINGS SHALL BE COMPRESSION AND CONCRETE TIGHT TYPE.
 - 4. NONMETALLIC CONDUIT AND FITTINGS SHALL BE SCHEDULE 40 PVC UNLESS SCHEDULE 80 PVC IS SPECIFIED. INSTALL USING SOLVENT-CEMENT-TYPE JOINTS AS RECOMMENDED BY THE MANUFACTURER.

B. CONDUCTORS AND CABLE:

- 1. CONDUCTORS AND CABLE SHALL BE FLAME-RETARDANT, MOISTURE AND HEAT RESISTANT THERMOPLASTIC, SINGLE CONDUCTOR, COPPER, TYPE THHN/THWN-2, 600 VOLT, SIZE AS INDICATED, #12 AWG SHALL BE THE MINIMUM SIZE CONDUCTOR USED.
- 2. #10 AWG AND SMALLER CONDUCTOR SHALL BE SOLID OR STRANDED AND #8 AWG AND LARGER CONDUCTORS SHALL BE STRANDED.
- 3. SOLDERLESS, COMPRESSION-TYPE CONNECTORS SHALL BE USED FOR TERMINATION OF ALL STRANDED CONDUCTORS.
- 4. STRAIN-RELIEF SUPPORTS GRIPS SHALL BE HUBBELL KELLEMS OR APPROVED EQUAL. CABLES SHALL BE SUPPORTED IN ACCORDANCE WITH THE NEC AND CABLE MANUFACTURER'S RECOMMENDATIONS.
- 5. ALL CONDUCTORS SHALL BE TAGGED AT BOTH ENDS OF THE CONDUCTOR, AT ALL PULL BOXES, J-BOXES, EQUIPMENT AND CABINETS AND SHALL BE IDENTIFIED WITH APPROVED PLASTIC TAGS (ACTION CRAFT, BRADY, OR APPROVED EQUAL).

C. DISCONNECT SWITCHES:

 DISCONNECT SWITCHES SHALL BE HEAVY DUTY, DEAD-FRONT, QUICK-MAKE, QUICK-BREAK, EXTERNALLY OPERABLE, HANDLE LOCKABLE AND INTERLOCK WITH COVER IN CLOSED POSITION, RATING AS INDICATED, UL LABELED FURNISHED IN NEMA 3R ENCLOSURE. SQUARE-D OR ENGINEER APPROVED EQUAL.

D. SYSTEM GROUNDING

- 1. ALL GROUNDING COMPONENTS SHALL BE TINNED AND GROUNDING CONDUCTOR SHALL BE #2 AWG BARE, SOLID, TINNED, COPPER. ABOVE GRADE GROUNDING CONDUCTORS SHALL BE INSULATED WHERE NOTED.
- GROUNDING BUSES SHALL BE BARE, TINNED ANNEALED COPPER BARS OF RECTANGULAR CROSS SECTION. STANDARD BUS BARS MGB, SHALL BE FURNISHED AND INSTALLED BY THE CONTRACTOR. THEY SHALL NOT BE FABRICATED OR MODIFIED IN THE FIELD. ALL GROUNDING BUSES SHALL BE IDENTIFIED WITH MINIMUM 3/4" LETTERS BY WAY OF STENCILING OR DESIGNATION PLATE.
- 3. CONNECTORS SHALL BE HIGH-CONDUCTIVITY, HEAVY DUTY, LISTED AND LABELED AS GROUNDING CONNECTORS FOR THE MATERIALS USED. USE TWO-HOLE COMPRESSION LUGS WITH HEAT SHRINK FOR MECHANICAL CONNECTIONS. INTERIOR CONNECTIONS USE TWO-HOLE COMPRESSION LUGS WITH INSPECTION WINDOW AND CLEAR HEAT SHRINK.
- 4. EXOTHERMIC WELDED CONNECTIONS SHALL BE PROVIDED IN KIT FORM AND SELECTED FOR THE SPECIFIC TYPES, SIZES, AND COMBINATIONS OF CONDUCTORS AND OTHER ITEMS TO BE CONNECTED.
- 5. GROUND RODS SHALL BE COPPER-CLAD STEEL WITH HIGH-STRENGTH STEEL CORE AND ELECTROLYTIC-GRADE COPPER OUTER SHEATH, MOLTEN WELDED TO CORE, 5/8"x10"-0". ALL GROUNDING RODS SHALL BE INSTALLED WITH INSPECTION SLEEVES.
- 6. INSTALL AN EQUIPMENT GROUNDING CONDUCTOR IN ALL CONDUITS IN COMPLIANCE WITH THE AT&T SPECIFICATIONS AND NEC. THE EQUIPMENT GROUNDING CONDUCTORS SHALL BE BONDED TO ALL METALLIC JUNCTION BOXES, PULLBOXES, DISCONNECT SWITCHES, STARTERS, AND EQUIPMENT.

E. OTHER MATERIALS:

- 1. THE CONTRACTOR SHALL PROVIDE OTHER MATERIALS, THOUGH NOT SPECIFICALLY DESCRIBED, WHICH ARE REQUIRED FOR A COMPLETELY OPERATIONAL SYSTEM AND PROPER INSTALLATION OF THE WORK.
- 2. PROVIDE PULL BOXES AND JUNCTION BOXES WHERE SHOWN OR REQUIRED BY NEC.

F. PANELS AND LOAD CENTERS:

1. ALL PANEL LABELS AND SCHEDULES SHALL BE TYPEWRITTEN.

EXECUTION:

GENERAL:

- A. ALL MATERIAL AND EQUIPMENT SHALL BE INSTALLED IN STRICT ACCORDANCE WITH THE MANUFACTURER'S RECOMMENDATIONS.
- B. EQUIPMENT SHALL BE TIGHTLY COVERED AND PROTECTED AGAINST DIRT OR WATER, AND AGAINST CHEMICAL OR MECHANICAL INJURY DURING INSTALLATION AND CONSTRUCTION PERIODS.

LABOR AND WORKMANSHIP:

- A. ALL LABOR FOR THE INSTALLATION OF MATERIALS AND EQUIPMENT FURNISHED FOR THE ELECTRICAL SYSTEM SHALL BE INSTALLED BY EXPERIENCED WIREMEN, IN A NEAT AND WORKMAN-LIKE MANNER.
- B. ALL ELECTRICAL EQUIPMENT SHALL BE ADJUSTED, ALIGNED AND TESTED BY THE CONTRACTOR AS REQUIRED TO PRODUCE THE INTENDED PERFORMANCE.
- C. UPON COMPLETION OF WORK, THE CONTRACTOR SHALL THOROUGHLY CLEAN ALL EXPOSED EQUIPMENT, REMOVE ALL LABELS AND ANY DEBRIS, CRATING OR CARTONS AND LEAVE THE INSTALLATION FINISHED AND READY FOR OPERATION.

VB BTS II, LLC

750 PARK OF COMMERCE DR, SUITE 200 BOCA RATON, FL 33487






TAMPA, FL 33634

FDH INFRASTRUCTURE SERVICES, LLC
6521 MERIDIEN DRIVE RALEIGH, NC 27616
PHONE: 919-755-1031

THE INFORMATION CONTAINED IN THIS SET OF DOCUMENTS IS PROPRIETARY BY NATURE. REPRODUCTION OR CAUSING TO BE REPRODUCED. THE WHOLE OR ANY PART OF THESE DRAWINGS WITHOUT THE PERMISSION OF FOH IS PROHIBITED.

SUBMITTALS					
REV	DATE	DESCRIPTION	BY	CHK'D	
0	03/17/2023	CONSTRUCTION	ZK	JRB	
		•			

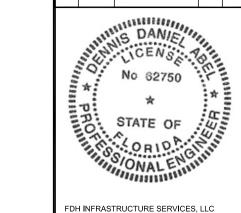

FDH INFRASTRUCTURE SERVICES, LLC DENNIS D. ABEL, PE STATE LICENNSE NO. 62750

FDH JOB NUMBER:

PR-008353

SITE ID:

US-FL-7140 SITE NAME:

HUNGRY HOWIE

T-MOBILE SITE ID:

A2B2227A

PARCEL: 252835000000023020

ADDRESS:

3024 SPIRIT LAKE DRIVE WINTER HAVEN, FL 33880

SHEET TITLE:

GENERAL NOTES

SHEET NUMBER:

ELECTRICAL NOTES (CONTINUED)

COORDINATION:

A. THE CONTRACTOR SHALL COORDINATE THE INSTALLATION OF ELECTRICAL ITEMS WITH THE OWNER-FURNISHED EQUIPMENT DELIVERY SCHEDULE TO PREVENT UNNECESSARY DELAYS IN THE TOTAL WORK

INSTALLATION:

A. CONDUIT:

- ALL ELECTRICAL WIRING SHALL BE INSTALLED IN CONDUIT AS SPECIFIED. NO CONDUIT OR TUBING OF LESS THAN 3/4 INCH TRADE SIZE.
- 2. PROVIDE RIGID PVC SCHEDULE 80 CONDUITS FOR ALL RISERS, OR WHERE RIGID OTHERWISE NOTED.
- INSTALL SCHEDULE 40 PVC CONDUIT WITH A MINIMUM COVER OF 24" UNDER ROADWAYS, PARKING LOTS, STREETS, AND ALLEYS. CONDUIT SHALL HAVE A MINIMUM COVER OF 18" IN ALL OTHER NON-TRAFFIC APPLICATIONS (REFER TO 2017 NEC, TABLE 300.5).
- 4. USE GALVANIZED FLEXIBLE STEEL CONDUIT WHERE DIRECT CONNECTION TO EQUIPMENT WITH MOVEMENT, VIBRATION, OR FOR EASE OF MAINTENANCE. USE LIQUID TIGHT, FLEXIBLE METAL CONDUIT FOR OUTDOOR APPLICATIONS. INSTALL GALVANIZED FLEXIBLE STEEL CONDUIT AT ALL POINTS OF CONNECTION TO EQUIPMENT MOUNTED ON SUPPORT TO ALLOW FOR EXPANSION AND CONTRACTION.
- A RUN OF CONDUIT BETWEEN BOXES OR EQUIPMENT SHALL NOT CONTAIN MORE THAN THE EQUIVALENT OF THREE 90 DEGREE BENDS MAX. CONDUIT BEND SHALL BE MADE WITH THE UL LISTED BENDER OR FACTORY 90 DEGREE ELBOWS MAY BE USED.
- 6. FIELD FABRICATED CONDUITS SHALL BE CUT SQUARE WITH A CONDUIT CUTTING TOOL AND REAMED TO PROVIDE A SMOOTH INSIDE SURFACE.
- 7. PROVIDE INSULATED GROUNDING BUSHING FOR ALL CONDUITS.
- 8. CONTRACTOR IS RESPONSIBLE FOR PROTECTING ALL CONDUITS DURING CONSTRUCTION. TEMPORARY OPENINGS IN THE CONDUIT SYSTEM SHALL BE PLUGGED OR CAPPED TO PREVENT ENTRANCE OF MOISTURE OR FOREIGN MATTER. CONTRACTOR SHALL REPLACE ANY CONDUITS CONTAINING FOREIGN MATERIALS THAT CANNOT BE REMOVED.
- ALL CONDUITS SHALL BE SWABBED CLEAN BY PULLING AN APPROPRIATE SIZE MANDREL THROUGH THE CONDUIT BEFORE INSTALLATION OF CONDUCTORS OR CABLES. CONDUIT SHALL BE FREE OF DIRT AND DEBRIS
- 10. INSTALL PULL STRINGS IN ALL CLEAN EMPTY CONDUITS. IDENTIFY PULL STRINGS AT EACH END.
- 11. INSTALL 2" HIGHLY VISIBLE AND DETECTABLE TAPE 12" ABOVE ALL UNDERGROUND CONDUITS AND CONDUCTORS.
- 12. CONDUITS SHALL BE INSTALLED IN SUCH A MANNER AS TO INSURE AGAINST COLLECTION OF TRAPPED CONDENSATION.
- 13. PROVIDE CORE DRILLING AS NECESSARY FOR PENETRATIONS TO ALLOW FOR RACEWAYS AND CABLES TO BE ROUTED THROUGH THE BUILDING. DO NOT PENETRATE STRUCTURAL MEMBERS AND/OR SLEEVES. PENETRATIONS IN FIRE RATED CONSTRUCTION SHALL BE EFFECTIVELY SEALED WITH FIRE RATED MATERIAL WHICH SHALL MAINTAIN THE FIRE RATING OF THE WALL OR STRUCTURE. FIRE STOPS AT FLOOR PENETRATIONS SHALL PREVENT PASSAGE OF WATER, SMOKE, FIRE, AND FUMES. ALL MATERIAL SHALL BE UL APPROVED FOR THE PURPOSE.

B. CONDUCTORS AND CABLE:

- 1. SPLICES SHALL BE MADE ONLY AT OUTLETS, JUNCTION BOXES, OR ACCESSIBLE RACEWAY CONDUITS APPROVED FOR THIS PURPOSE.
- 2. PULLING LUBRICANTS SHALL BE UL APPROVED. CONTRACTOR SHALL USE NYLON OR HEMP ROPE FOR PULLING CONDUCTOR OR CABLES INTO THE CONDUIT.
- 3. CABLES SHALL BE NEATLY TRAINED, WITHOUT INTERLACING, AND BE OF SUFFICIENT LENGTH IN ALL BOXES AND EQUIPMENT TO PERMIT MAKING A NEAT ARRANGEMENT. CABLES SHALL BE SECURED IN A MANNER TO AVOID TENSION ON CONDUCTORS OR TERMINALS. CONDUCTORS SHALL BE PROTECTED FROM MECHANICAL INJURY AND MOISTURE. SHARP BENDS OVER CONDUIT BUSHINGS IS PROHIBITED. DAMAGED CABLES SHALL BE REMOVED AND REPLACED AT THE CONTRACTOR'S EXPENSE.

C. DISCONNECT SWITCHES:

1. INSTALL DISCONNECT SWITCHES LEVEL AND PLUMB. CONNECT TO WIRING SYSTEM AND GROUNDING SYSTEM AS INDICATED.

D. GROUNDING:

- ALL METALLIC PARTS OF ELECTRICAL EQUIPMENT WHICH DO NOT CARRY CURRENT SHALL BE GROUNDED IN ACCORDANCE WITH THE REQUIREMENTS OF THE BUILDING MANUFACTURER, AT&T GROUNDING AND BONDING STANDARDS, LATEST EDITION, AND COMPLY WITH AT&T GROUNDING CHECKLIST, LATEST VERSION, AND THE NATIONAL ELECTRICAL CODE.
- PROVIDE ELECTRICAL GROUNDING AND BONDING SYSTEM INDICATED WITH ASSEMBLY OF MATERIALS, INCLUDING GROUNDING ELECTRODES, BONDING JUMPERS AND ADDITIONAL ACCESSORIES AS REQUIRED FOR A COMPLETE INSTALLATION.

- 3. ALL GROUNDING CONDUCTORS SHALL PROVIDE A STRAIGHT DOWNWARD PATH TO GROUND WITH GRADUAL BEND AS REQUIRED. GROUNDING CONDUCTORS SHALL NOT BE LOOPED OR SHARPLY BENT. ROUTE GROUNDING CONNECTIONS AND CONDUCTORS TO GROUND IN THE SHORTEST AND STRAIGHTEST PATHS POSSIBLE TO MINIMIZE TRANSIENT VOLTAGE RISES.
- 4. BUILDINGS AND/OR NEW TOWERS GREATER THAN 75 FEET IN HEIGHT AND WHERE THE MAIN GROUNDING CONDUCTORS ARE REQUIRED TO BE ROUTED TO GRADE, THE CONTRACTOR SHALL ROUTE TWO GROUNDING CONDUCTORS FROM THE ROOFTOP, TOWER, AND WATER TOWERS GROUNDING RING, TO THE EXISTING GROUNDING SYSTEM, THE GROUNDING CONDUCTORS SHALL NOT BE SMALLER THAN 2/0 AWG COPPER. ROOFTOP GROUNDING RING SHALL BE BONDED TO THE EXISTING GROUNDING SYSTEM, THE BUILDING STEEL COLUMNS, LIGHTNING PROTECTION SYSTEM, AND BUILDING MAIN WATER LINE (FERROUS OR NONFERROUS METAL PIPING ONLY). SEE STANDARD 6.3.2.2.
- 5. TIGHTEN GROUNDING AND BONDING CONNECTORS, INCLUDING SCREWS AND BOLTS, IN ACCORDANCE WITH MANUFACTURER'S PUBLISHED TORQUE TIGHTENING VALUES FOR CONNECTORS AND BOLTS. WHERE MANUFACTURER'S TORQUING REQUIREMENTS ARE NOT AVAILABLE, INFITED TO CONNECTIONS TO COMPLY WITH TIGHTENING TORQUE VALUES SPECIFIED IN ULITO ASSURE PERMANENT AND EFFECTIVE GROUNDING
- 6. CONTRACTOR SHALL VERIFY THE LOCATIONS OF GROUNDING TIE-IN-POINTS TO THE EXISTING GROUNDING SYSTEM. ALL UNDERGROUND GROUNDING CONNECTIONS SHALL BE MADE BY THE EXOTHERMIC WELD PROCESS AND INSTALLED IN ACCORDANCE WITH THE MANUFACTURER'S INSTRUCTIONS.
- ALL GROUNDING CONNECTIONS SHALL BE INSPECTED FOR TIGHTNESS. EXOTHERMIC WELDED CONNECTIONS
 SHALL BE APPROVED BY THE INSPECTOR HAVING JURISDICTION BEFORE BEING PERMANENTLY CONCEALED.
- APPLY CORROSION-RESISTANT FINISH TO FIELD CONNECTIONS AND PLACES WHERE FACTORY APPLIED PROTECTIVE COATINGS HAVE BEEN DESTROYED. USE KOPR-SHIELD ANTI-OXIDATION COMPOUND ON ALL COMPRESSION GROUNDING CONNECTIONS
- A SEPARATE, CONTINUOUS, INSULATED EQUIPMENT GROUNDING CONDUCTOR SHALL BE INSTALLED IN ALL FEEDER AND BRANCH CIRCUITS.
- 10. BOND ALL INSULATED GROUNDING BUSHINGS WITH A BARE #6 AWG GROUNDING CONDUCTOR TO A GROUND BUS
- 11. DIRECT BURIED GROUNDING CONDUCTORS SHALL BE INSTALLED AT A NOMINAL DEPTH OF 30" MINIMUM BELOW GRADE, OR 6" BELOW THE FROST LINE, USE THE GREATER OF THE TWO DISTANCES.
- 12. ALL GROUNDING CONDUCTORS EMBEDDED IN OR PENETRATING CONCRETE SHALL BE INSTALLED IN SCHEDULE 40 PVC CONDUIT.
- 13. DRIVE GROUND RODS UNTIL TOPS ARE A MINIMUM DISTANCE OF 30" DEPTH OR 6" BELOW FROST LINE, USING THE GREATER OF THE TWO DISTANCES.
- 14. CONTRACTOR SHALL REPAIR, AND/OR REPLACE, EXISTING GROUNDING SYSTEM COMPONENTS DAMAGED DURING CONSTRUCTION AT THE CONTRACTORS EXPENSE.

ACCEPTANCE TESTING:

- A. CERTIFIED PERSONNEL USING CERTIFIED EQUIPMENT SHALL PERFORM REQUIRED TESTS AND SUBMIT WRITTEN TEST REPORTS UPON COMPLETION.
- B. WHEN MATERIAL AND/OR WORKMANSHIP IS FOUND NOT TO COMPLY WITH THE SPECIFIED REQUIREMENTS, THE NON-COMPLYING ITEMS SHALL BE REMOVED FROM THE PROJECT SITE AND REPLACED WITH ITEMS COMPLYING WITH THE SPECIFIED REQUIREMENTS PROMPTLY AFTER RECEIPT OF NOTICE FOR NON-COMPLIANCE.

C. TEST PROCEDURES:

- ALL FEEDERS SHALL HAVE INSULATION TESTED AFTER INSTALLATION, BEFORE CONNECTION TO DEVICES. THE CONDUCTORS SHALL TEST FREE FROM SHORT CIRCUITS AND GROUNDS. TESTING SHALL BE FOR ONE MINUTE USING 1000V DC. PROVIDE WRITTEN DOCUMENTATION FOR ALL TEST RESULTS.
- PRIOR TO ENERGIZING CIRCUITRY, TEST WIRING DEVICES FOR ELECTRICAL CONTINUITY AND PROPER POLARITY CONNECTIONS.
- MEASURE AND RECORD VOLTAGES BETWEEN PHASES AND BETWEEN PHASE CONDUCTORS AND NEUTRALS, SUBMIT A REPORT OF MAXIMUM AND MINIMUM VOLTAGES.
- 4. PERFORM GROUNDING TEST TO MEASURE GROUNDING RESISTANCE OF GROUNDING SYSTEM USING THE IEEE STANDARD 3-POINT "FALL-OF-POTENTIAL" METHOD. PROVIDE PLOTTED TEST VALUES AND LOCATION SKETCH. NOTIFY THE ENGINEER IMMEDIATELY IF MEASURED VALUE IS OVER 5 OHMS.

VB BTS II, LLC

750 PARK OF COMMERCE DR, SUITE 200 BOCA RATON, FL 33487




SUITE 110 A-B TAMPA, FL 33634



FDH INFRASTRUCTURE SERVICES, LLC 6521 MERIDIEN DRIVE RALEIGH, NC 27616 PHONE: 919-755-1012 FAX: 919-755-1031

THE INFORMATION CONTAINED IN THIS SET OF DOCUMENTS IS PROPRIETARY BY NATURE. REPRODUCTION OR CAUSING TO BE REPRODUCED THE WHOLE OR ANY PART OF THESE DRAWINGS WITHOUT THE PERMISSION OF FOH IS PROHIBITED.

SUBMITTALS					
REV	DATE	DESCRIPTION	BY	CHK'D	
0	03/17/2023	CONSTRUCTION	ZK	JRB	

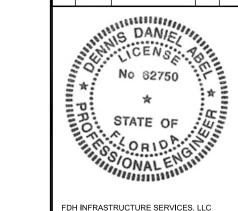

FDH INFRASTRUCTURE SERVICES, LLC DENNIS D. ABEL, PE STATE LICENNSE NO. 62750

FDH JOB NUMBER

PR-008353

SITE ID:

US-FL-7140 SITE NAME:

HUNGRY HOWIE

T-MOBILE SITE ID:

A2B2227A

PARCEL: 252835000000023020

ADDRESS:

3024 SPIRIT LAKE DRIVE WINTER HAVEN, FL 33880

SHEET TITLE:

GENERAL NOTES

SHEET NUMBER:



RF NOTICE SIGN (WHITE METAL SIGN W/ BLACK LETTERING)



EMERGENCY SIGN (RED METAL SIGN W/ WHITE LETTERING)

T-MOBILE SIGN DETAIL

11"x17" SCALE: N.T.S. 24"x36" SCALE: N.T.S.




OWNED BY: VERTICAL BRIDGE

TELEPHONE: 877-589-6411

www.verticalbridge.com

WWW.VERTICALBRIDGE.COM SALES @ VERTICALBRIDGE.COM OPERATIONS @ VERTICALBRIDGE.COM

NO TRESPASSING

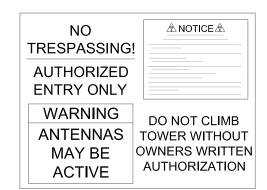

18"x24" .040 ALUMINUM

NO TRESPASSING SIGN DETAIL

11"x17" SCALE: N.T.S. 24"x36" SCALE: N.T.S. BTS II, LLC

750 PARK OF COMMERCE DR, SUITE 200 BOCA RATON, FL 33487






ENGINEERING INNOVATION
FDH INFRASTRUCTURE SERVICES, LLC
6521 MERIDIEN DRIVE RALEIGH, NC 27616
PHONE: 919-755-1012 FAX: 919-755-1031

THE INFORMATION CONTAINED IN THIS SET OF DOCUMENTS IS PROPRIETARY BY MATURE. REPRODUCTION OR CAUSING TO BE REPRODUCED THE WHOLE OR ANY PART OF THESE DRAWINGS WITHOUT THE PERMISSION OF FDH IS PROHIBITED.

SUBMITTALS							
REV	DATE	DESCRIPTION	BY	СНК			
0	03/17/2023	CONSTRUCTION	ZK	JRE			

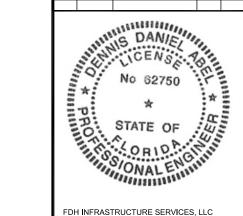

FDH INFRASTRUCTURE SERVICES, LLC DENNIS D. ABEL, PE STATE LICENINSE NO. 62750

FDH JOB NUMBER:

PR-008353

US-FL-7140

SITE NAME:

HUNGRY HOWIE

T-MOBILE SITE ID:

A2B2227A

, LEBELE,

252835000000023020

ADDRESS:

3024 SPIRIT LAKE DRIVE WINTER HAVEN, FL 33880

SHEET TITL

SIGN DETAILS

SHEET NUMBER:



FUTURE LAND USE LEGEND:

RL-3

RL-1

LAKE

BTS II, LLC

750 PARK OF COMMERCE DR, SUITE 200 BOCA RATON, FL 33487



5901 BENJAMIN CENTER DR. SUITE 110 A-B TAMPA, FL 33634



ENGINEERING INNOVATION

FDH INFRASTRUCTURE SERVICES, LLC
6521 MERIDIEN DRIVE RALEIGH, NC 27616
PHONE: 919-755-1012 FAX: 919-755-1031

THE INFORMATION CONTAINED IN THIS SET OF DOCUMENTS IS PROPRIETARY BY NATURE. REPRODUCTION OR CAUSING TO BE REPRODUCED THE WHOLE OR ANY PART OF THESE DRAWINGS WITHOUT THE PERMISSION OF FDH IS PROHIBITED.

SUBMITTALS

REV	DATE	DESCRIPTION	BY	CHK'D
0	03/17/2023	CONSTRUCTION	ZK	JRB



FDH INFRASTRUCTURE SERVICES, LLC DENNIS D. ABEL, PE STATE LICENNSE NO. 62750

FDH JOB NUMBER:

PR-008353

US-FL-7140 SITE NAME:

HUNGRY HOWIE

T-MOBILE SITE ID:

A2B2227A

252835000000023020 ADDRESS:

3024 SPIRIT LAKE DRIVE WINTER HAVEN, FL 33880


SHEET TITLE:

ZONING & LAND USE

SHEET NUMBER:

Z-1



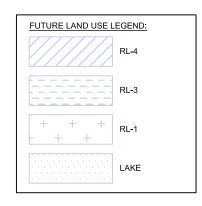

BTS II, LLC

750 PARK OF COMMERCE DR, SUITE 200 BOCA RATON, FL 33487



5901 BENJAMIN CENTER DR. SUITE 110 A-B TAMPA, FL 33634



INFRASTRUCTURE SERVICES

SERVICES

ENGINEERING INNOVATION
FOH INFRASTRUCTURE SERVICES, LLC
6521 MERIDIEN DRIVE RALEIGH, NC 27616
PHONE: 919-755-1012 FAX: 919-755-1031

THE INFORMATION CONTAINED IN THIS SET OF DOCUMENTS IS PROPRIETARY BY NATURE. REPRODUCTION OR CAUSING TO BE REPRODUCED THE WHOLE OR ANY PART OF THESE DRAWINGS WITHOUT THE PERMISSION OF FDH IS PROHIBITED.

SUBMITTALS

REV	DATE	DESCRIPTION	BY	CHK'D
0	03/17/2023	CONSTRUCTION	ZK	JRB



FDH INFRASTRUCTURE SERVICES, LLC DENNIS D. ABEL, PE STATE LICENNSE NO. 62750

FDH JOB NUMBER:

PR-008353

SITE ID:

US-FL-7140 SITE NAME:

HUNGRY HOWIE

T-MOBILE SITE ID:

A2B2227A

PARCEL:

252835000000023020

ADDRESS:


3024 SPIRIT LAKE DRIVE WINTER HAVEN, FL 33880

SHEET TITLE:

ZONING & LAND USE

SHEET NUMBER:


Z-2

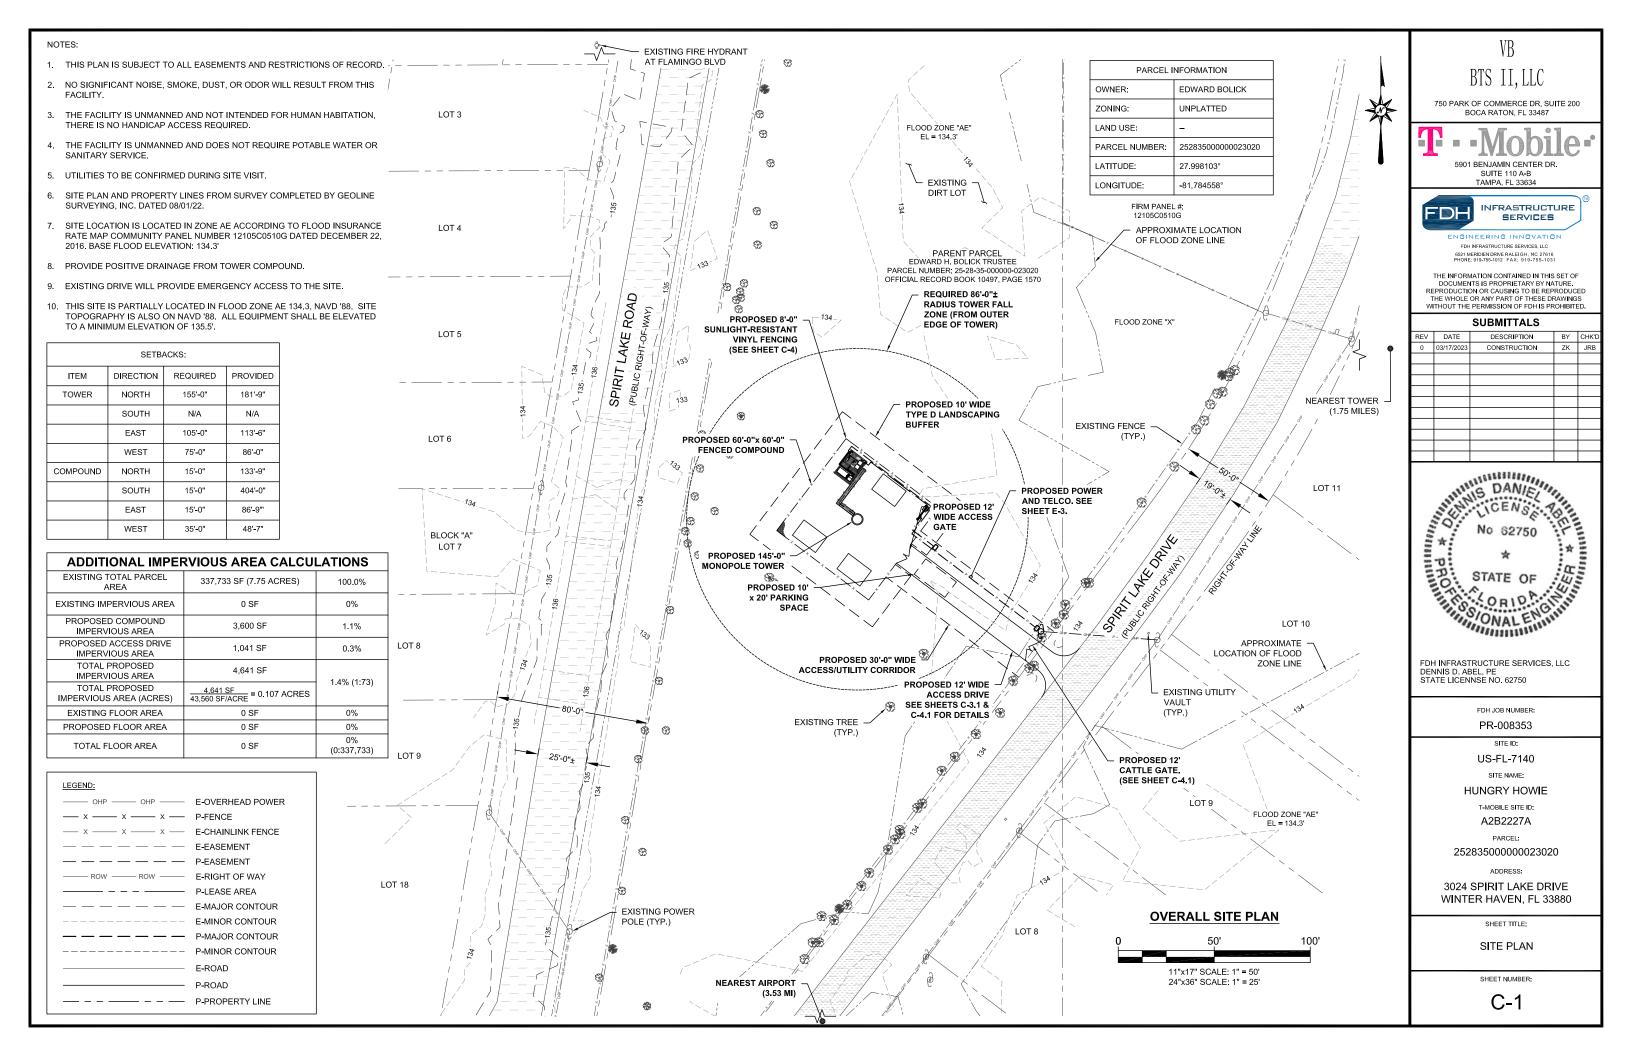


NOTES:

- 1.) THIS PLAN IS SUBJECT TO ALL EASEMENTS AND RESTRICTIONS OF RECORD.
- 2.) NO SIGNIFICANT NOISE, SMOKE, DUST, OR ODOR WILL RESULT FROM THIS FACILITY.
- 3.) THE FACILITY IS UNMANNED AND NOT INTENDED FOR HUMAN HABITATION, THERE IS NO HANDICAP ACCESS REQUIRED.
- 4.) THE FACILITY IS UNMANNED AND DOES NOT REQUIRE POTABLE WATER OR SANITARY SERVICE.
- 5.) UTILITIES TO BE CONFIRMED DURING SITE VISIT.
- 6.) SITE PLAN AND PROPERTY LINES FROM SURVEY COMPLETED BY GEOLINE SURVEYING, INC. DATED 08/01/22.
- 7.) SITE LOCATION IS LOCATED IN ZONE AE ACCORDING TO FLOOD INSURANCE RATE MAP COMMUNITY PANEL NUMBER 12105C0510G DATED DECEMBER 22, 2016. BASE FLOOD ELEVATION: 134.3'
- 8.) PROVIDE POSITIVE DRAINAGE FROM TOWER COMPOUND.
- 9.) EXISTING DRIVE WILL PROVIDE EMERGENCY ACCESS TO THE SITE.
- 10.) THIS SITE IS PARTIALLY LOCATED IN FLOOD ZONE AE 134.3, NAVD '88. SITE TOPOGRAPHY IS ALSO ON NAVD '88. ALL EQUIPMENT SHALL BE ELEVATED TO A MINIMUM ELEVATION OF 135.5'.

SETBACKS:				
ITEM DIRECTION REQUIRED PROVIDED				
TOWER	NORTH	155'-0"	181'-9"	
	SOUTH	N/A	N/A	
	EAST	105'-0"	113'-6"	
	WEST	75'-0"	86'-0"	
COMPOUND	NORTH	15'-0"	167'-8"	
	SOUTH	15'-0"	414'-0"	
	EAST	15'-0"	96'-9"'	
	WEST	35'-0"	62'-0"	

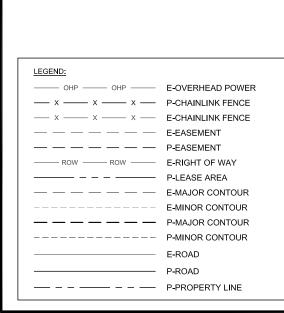

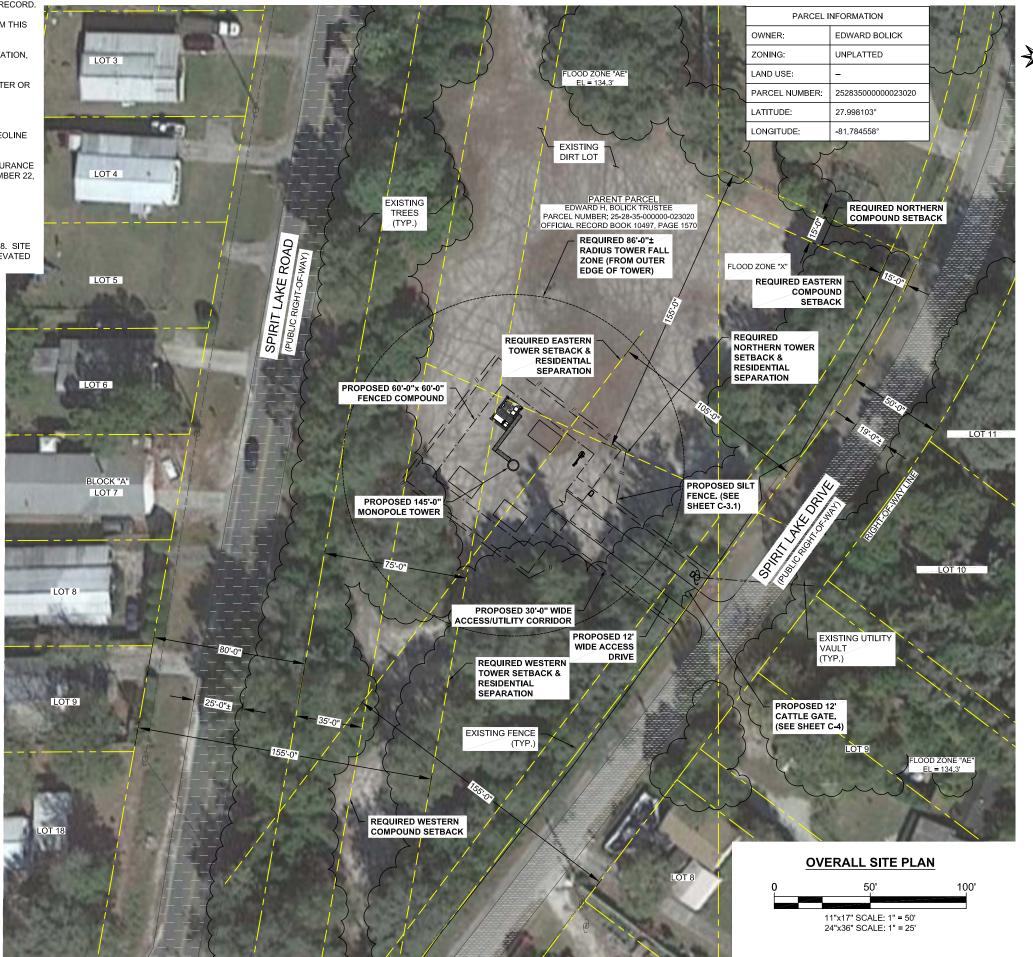

750 PARK OF COMMERCE DR, SUITE 200



TAMPA FL 33634

BOCA RATON, FL 33487



ENGINEERING INNOVATION FDH INFRASTRUCTURE SERVICES, LLC

THE INFORMATION CONTAINED IN THIS SET OF DOCUMENTS IS PROPRIETARY BY NATURE

Т	REPRODUCTION OR CAUSING TO BE REPRODUCED THE WHOLE OR ANY PART OF THESE DRAWINGS WITHOUT THE PERMISSION OF FDH IS PROHIBITED.						
SUBMITTALS							
EV	DATE	DESCRIPTION	BY	СН			
0	03/17/2023	CONSTRUCTION	ZK	JF			

REV	DATE	DESCRIPTION	BY	CHK'D
0	03/17/2023	CONSTRUCTION	ZK	JRB



FDH INFRASTRUCTURE SERVICES, LLC DENNIS D. ABEL, PE STATE LICENNSE NO. 62750

FDH JOB NUMBER:

PR-008353

SITE ID:

US-FL-7140

SITE NAME: **HUNGRY HOWIE**

T-MOBILE SITE ID:

A2B2227A

252835000000023020 ADDRESS:


3024 SPIRIT LAKE DRIVE WINTER HAVEN, FL 33880

SHEET TITLE:

AERIAL SITE PLAN

SHEET NUMBER:

C-1.1

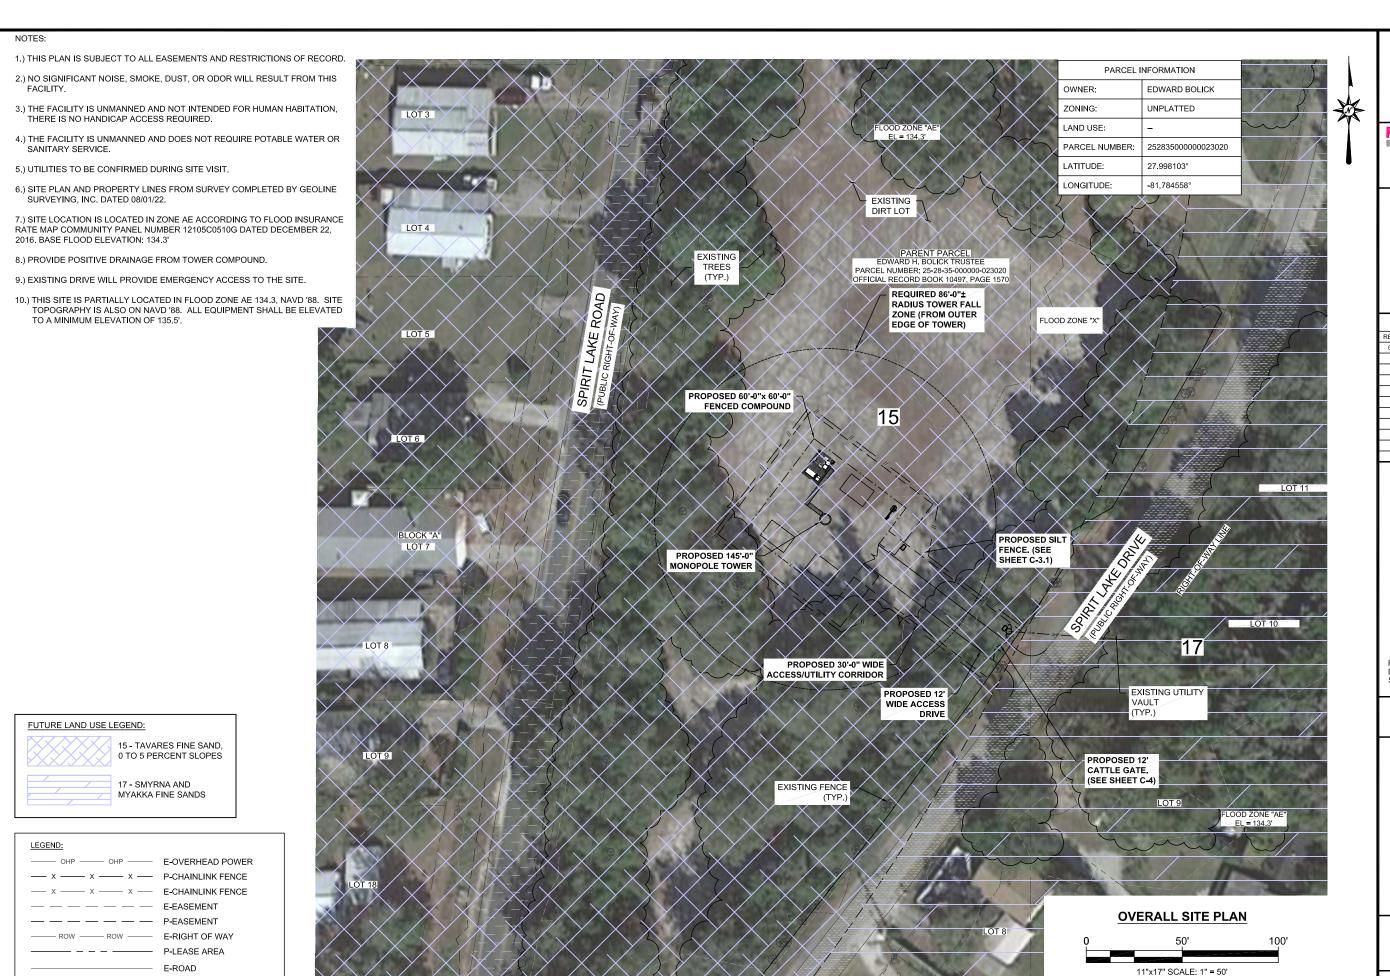

P-ROAD

— - - - - P-PROPERTY LINE

RTS II II(

750 PARK OF COMMERCE DR, SUITE 200 BOCA RATON, FL 33487





SERVICES

FDH INFRASTRUCTURE SERVICES, LLC
6521 MERIDIEN DRIVE RALEIGH, NC 27616
PHONE: 919-755-1012 FAX: 919-755-1031

THE INFORMATION CONTAINED IN THIS SET OF DOCUMENTS IS PROPRIETARY BY NATURE. REPRODUCTION OR CAUSING TO BE REPRODUCED THE WHOLE OR ANY PART OF THESE DRAWINGS WITHOUT THE PERMISSION OF FDH IS PROHIBITED.

S	u	R	M	ITT	Δ	S

REV	DATE	DESCRIPTION	BY	CHK'D
0	03/17/2023	CONSTRUCTION	ZK	JRB



FDH INFRASTRUCTURE SERVICES, LLC DENNIS D. ABEL, PE STATE LICENNSE NO. 62750

FDH JOB NUMBER:

PR-008353

SITE ID:

US-FL-7140

SITE NAME:
HUNGRY HOWIE

T-MOBILE SITE ID:

A2B2227A

, LDZZZ, ,

252835000000023020

ADDRESS:

3024 SPIRIT LAKE DRIVE WINTER HAVEN, FL 33880


SHEET TITLE:

SOIL SITE PLAN

SHEET NUMBER:

24"x36" SCALE: 1" = 25'

C-1.2

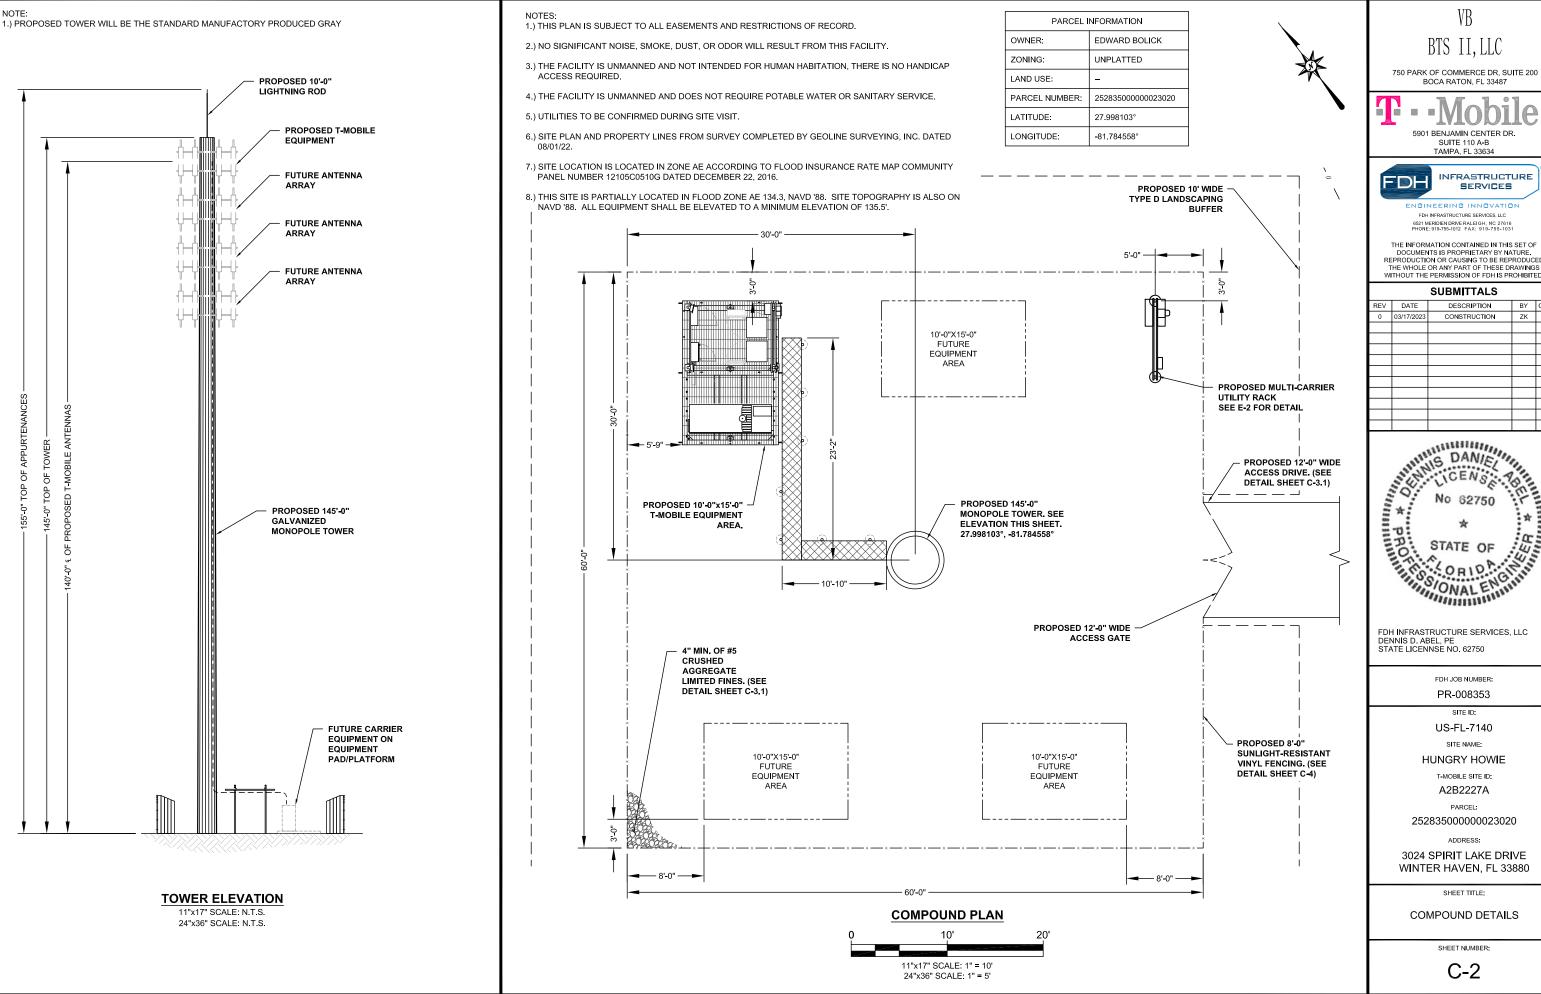

BOCA RATON, FL 33487





THE INFORMATION CONTAINED IN THIS SET OF DOCUMENTS IS PROPRIETARY BY NATURE.
REPRODUCTION OR CAUSING TO BE REPRODUCED
THE WHOLE OR ANY PART OF THESE DRAWINGS
WITHOUT THE PERMISSION OF FDH IS PROHIBITED.

	SUBMITTALS				
REV	DATE	DESCRIPTION	BY	CHK'	
0	03/17/2023	CONSTRUCTION	ZK	JRB	



WINTER HAVEN, FL 33880


COMPOUND DETAILS

SHEET NUMBER:


NOTE:

THE PLATFORM DETAILS ON THIS SHEET ARE FOR SCHEMATIC PURPOSES ONLY. REFER TO SHEETS SN-1 THROUGH S-7 FOR ACTUAL PLATFORM DETAILS...



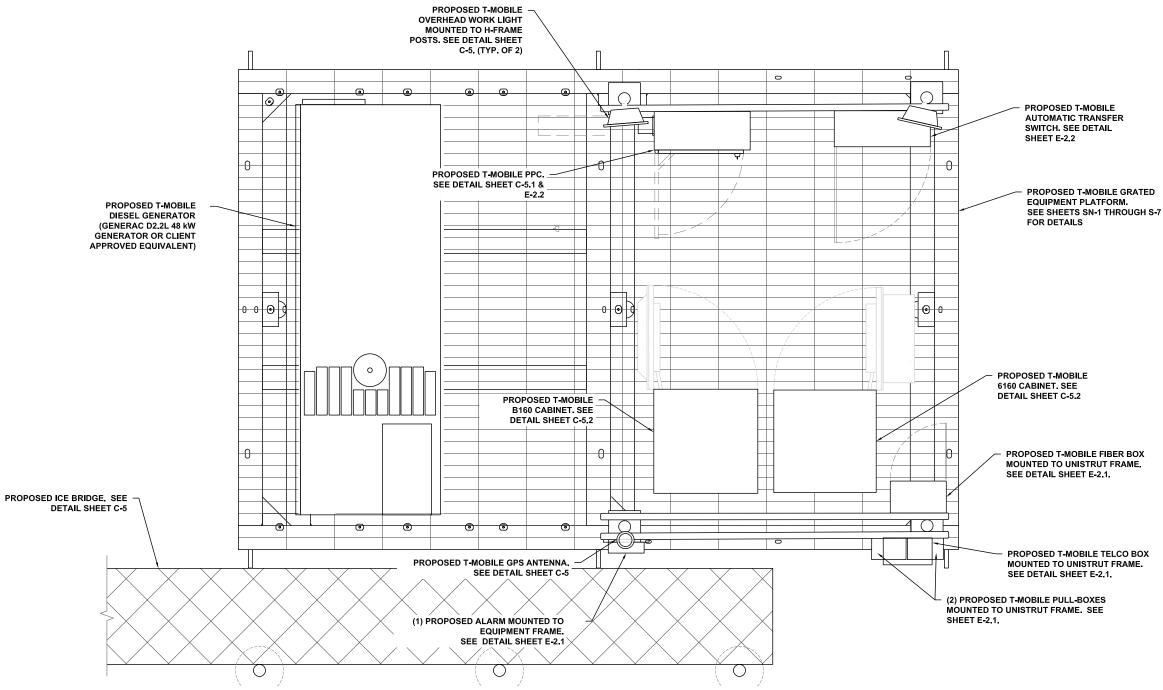

T-MOBILE EQUIPMENT LAYOUT

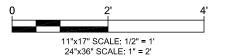

VB TS II II C

BTS II, LLC
750 PARK OF COMMERCE DR, SUITE 200



5901 BENJAMIN CENTER DR. SUITE 110 A-B TAMPA. FL 33634




FDH INFRASTRUCTURE SERVICES, LLC 6521 MERIDIEN DRIVE RALEIGH, NC 27616 PHONE: 919-755-1012 FAX: 919-755-1031

THE INFORMATION CONTAINED IN THIS SET OF DOCUMENTS IS PROPRIETARY BY NATURE. REPRODUCTION OR CAUSING TO BE REPRODUCED THE WHOLE OR ANY PART OF THESE DRAWINGS WITHOUT THE PERMISSION OF FDH IS PROHIBITED.

SUBMITTALS

REV	DATE	DESCRIPTION	BY	CHK'
0	03/17/2023	CONSTRUCTION	ZK	JRB

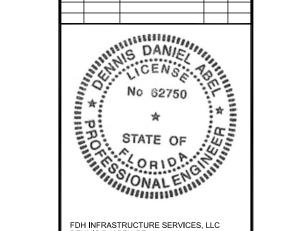

FDH INFRASTRUCTURE SERVICES, LLC DENNIS D. ABEL, PE STATE LICENNSE NO. 62750

FDH JOB NUMBER:

PR-008353

SITE ID: US-FL-7140

SITE NAME:

HUNGRY HOWIE

T-MOBILE SITE ID:

A2B2227A

252835000000023020

ADDRESS:


3024 SPIRIT LAKE DRIVE WINTER HAVEN, FL 33880

SHEET TITL

T-MOBILE EQUIPMENT LAYOUT

SHEET NUMBER:

C-2.1

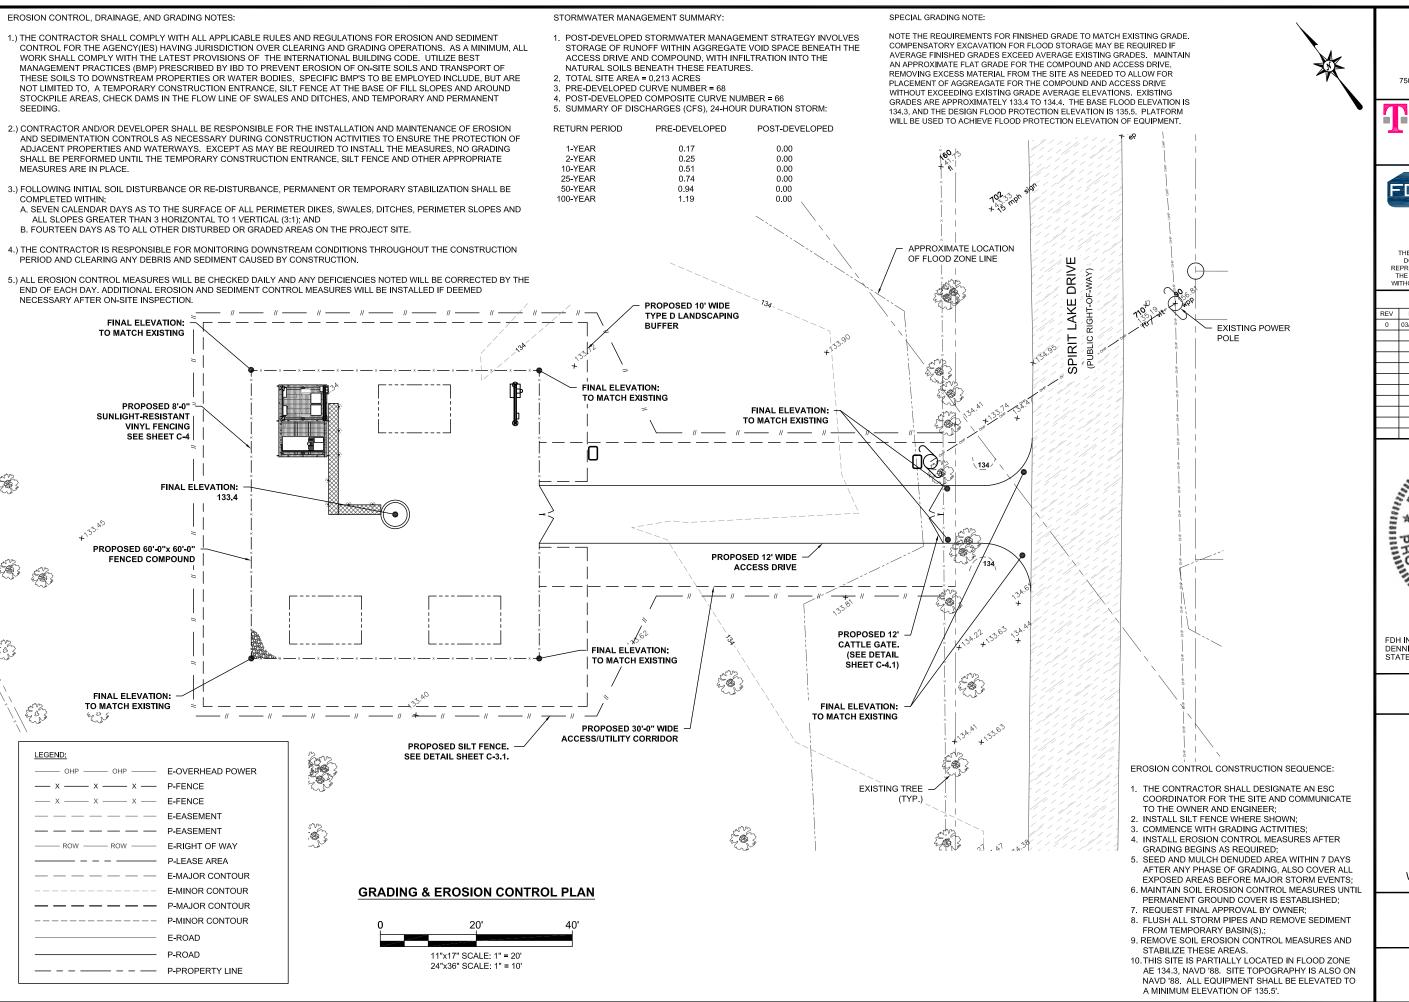

BTS II, LLC

750 PARK OF COMMERCE DR, SUITE 200 BOCA RATON, FL 33487





TAMPA FL 33634

ENGINEERING INNOVATION

FDH INFRASTRUCTURE SERVICES, LLC 6521 MERIDIEN DRIVE RALEIGH, NC 27616 PHONE: 919-755-1012 FAX: 919-755-1031

THE INFORMATION CONTAINED IN THIS SET OF DOCUMENTS IS PROPRIETARY BY NATURE. REPRODUCTION OR CAUSING TO BE REPRODUCED THE WHOLE OR ANY PART OF THESE DRAWINGS WITHOUT THE PERMISSION OF FOH IS PROHIBITED

	002				
REV	DATE	DESCRIPTION	BY	СНК	
0	03/17/2023	CONSTRUCTION	ZK	JRI	



FDH INFRASTRUCTURE SERVICES, LLC DENNIS D. ABEL, PE STATE LICENNSE NO. 62750

FDH JOB NUMBER:

PR-008353

SITE ID:

US-FL-7140

SITE NAME:
HUNGRY HOWIE

T-MOBILE SITE ID:

A2B2227A

LDLLLIII

252835000000023020

ADDRESS:

3024 SPIRIT LAKE DRIVE WINTER HAVEN, FL 33880

SHEET TITLE:

GRADING & EROSION CONTROL PLAN

SHEET NUMBER:


C-3


NOTES:

- 1. REMOVE ALL TOPSOIL, ORGANIC MATERIAL, AND WET OR POOR SOILS FROM PROPOSED COMPOUND AREA. CONTRACTOR TO REVIEW SITE CONDITIONS AND CONSULT GEOTECHNICAL REPORT FOR ANTICIPATED DEPTH OF SOILS THAT WILL REQUIRE REMOVAL IF POOR SOILS ARE ENCOUNTERED AT A DEPTH OF MORE THAN 12", CONTACT CONSTRUCTION MANAGER FOR GUIDANCE
- 2. SUBGRADE TO BE COMPACTED TO 95% ASTM D698 AND VERIFIED BY PROOF-ROLL OR GEOTECHNICAL RECOMMENDATIONS.

SUBGRADE TO BE COMPACTED TO 95% ASTM D698 DRY DENSITY AND VERIFIED BY PROOF-ROLL OR GEOTECHNICAL

- 3. IF THE GEOTECHNICAL REPORT PERMITS, USE ONSITE SOILS FOR SELECT FILL PROVIDED IT IS AVAILABLE AND FREE OF DELETERIOUS MATERIALS AND ORGANICS.
- 4. SEASONAL HIGH WATER TABLE MAY BE AT EXISTING GROUND SURFACE

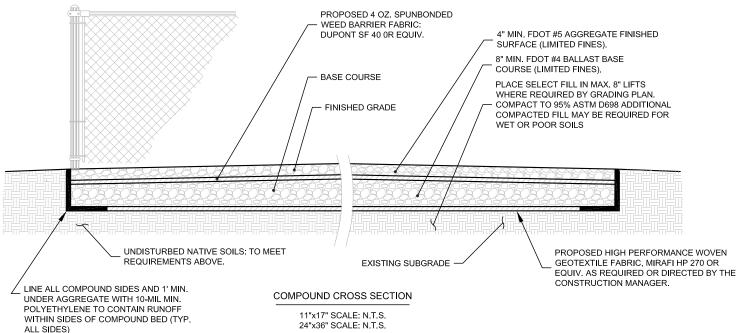

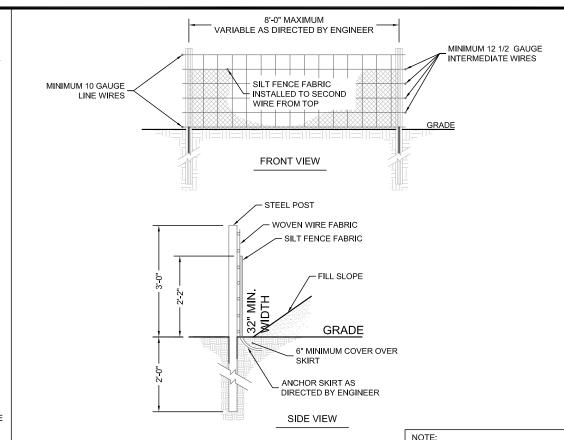

TEMPORARY SILT FENCE DETAIL

11"x17" SCALE: N.T.S. 24"x36" SCALE: N.T.S. USE SILT FENCE ONLY WHEN
DRAINAGE AREA DOES NOT EXCEED
1/4 ACRE AND NEVER IN AREAS OF
CONCENTRATED FLOW.

GRAVEL DRIVE REQUIREMENTS:

THICKNESS OF GRAVEL DRIVE BASE COURSE TO BE DETERMINED BASED ON THE EXISTING SOIL BEARING CAPACITY (PER UFC DESIGN RECOMMENDATIONS):

IF POOR OR WET SOILS ARE PRESENT BELOW BASE COURSE, CONTRACTOR TO INSTALL 6" MIN. WELL-GRADED GRAVEL/SAND SUB-BASE TO FACILITATE ADEQUATE DRAINAGE AND STABILITY.

FOR ACCESS DRIVE SLOPES GREATER THAN 10%, CONTRACTOR TO USE MIRAFI HP 270 OR EQUIVALENT GEOTEXTILE FABRIC.

BEARING CAPACITY		REQ'D AGGREGATE THICKNESS				
1000 PSF		*16" MIN.				
1500 PSF		12" MIN.				
2000 PSF		8" MIN. (SEE DETAIL)				
	*A HIGH PERFORMANCE WOVEN GEOTEXTILE FABRIC MAY BE USED TO					

*A HIGH PERFORMANCE, WOVEN GEOTEXTILE FABRIC MAY BE USED I REPLACE 6" OF AGGREGATE (MIRAFI HP 270 OR EQUIVALENT)

> - LINE SIDES AND 1' MIN. UNDER AGGREGATE WITH 10-MIL MIN. POLYETHYLENE TO CONTAIN RUNOFF WITHIN SIDES OF ROAD BED (TYP. EA SIDE)

NOTE:

11"x17" SCALE: N.T.S. 24"x36" SCALE: N.T.S.

REMOVE ALL TOPSOIL, ORGANIC MATERIAL, AND WET OR POOR SOILS ALONG ACCESS DRIVE. CONTRACTOR TO REVIEW SITE
CONDITIONS AND CONSULT GEOTECHNICAL REPORT FOR ANTICIPATED DEPTH OF SOILS THAT WILL REQUIRE REMOVAL. IF
POOR SOILS ARE ENCOUNTERED AT A DEPTH OF MORE THAN 12", CONTACT CONSTRUCTION MANAGER FOR GUIDANCE.


FOR FLOODPLAIN STORAGE COMPLIANCE, ALL MATERIAL EXCAVATED FOR CONSTRUCTION OF THE COMPOUND, ACCESS DRIVE AND RETENTION BASINS SHALL BE REMOVED AND DISPOSED OF OFF SITE. PLACEMENT OF 10-MIL POLYETHYLENE AROUND PERIMETER AND UP TO SURFACE IS CRITICAL TO PROPER STORMWATER MANAGEMENT PERFORMANCE.

4. CRUSH AND RUN AGGREGATE CANNOT BE USED. RESTORATION:

RECOMMENDATIONS.

3. CONSULT GRADING PLAN OR SITE PLAN FOR FINAL SITE GRADES.

NOTES:

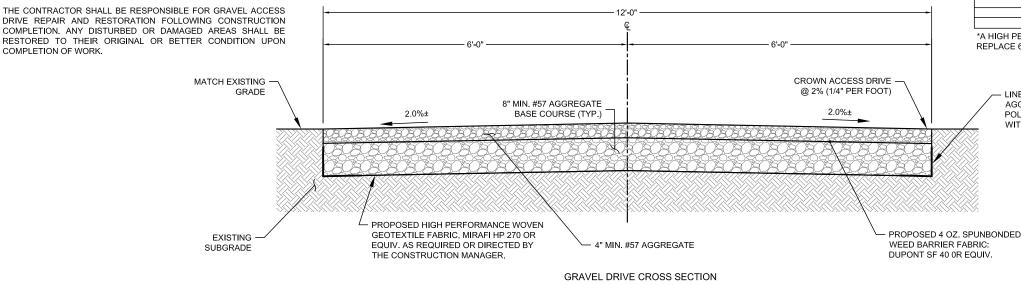

BTS II, LLC

750 PARK OF COMMERCE DR, SUITE 200 BOCA RATON, FL 33487






TAMPA FL 33634

ENGINEERING INNOVATION
FDH INFRASTRUCTURE SERVICES, LLC

6521 MERIDIEN DRIVE RALEIGH, NC 27616 PHONE: 919-755-1012 FAX: 919-755-1031

THE INFORMATION CONTAINED IN THIS SET OF DOCUMENTS IS PROPRIETARY BY NATURE. REPRODUCTION OR CAUSING TO BE REPRODUCED THE WHOLE OR ANY PART OF THESE DRAWINGS WITHOUT THE PERMISSION OF FDH IS PROHIBITED.

	SUBMITTALS					
REV	DATE	DESCRIPTION	BY	CHK'E		
0	03/17/2023	CONSTRUCTION	ZK	JRB		

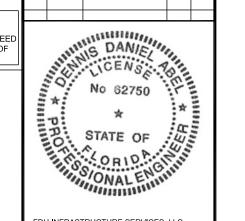

FDH INFRASTRUCTURE SERVICES, LLC DENNIS D. ABEL, PE STATE LICENNSE NO. 62750

FDH JOB NUMBER:

PR-008353

SITE ID:

US-FL-7140 SITE NAME:

HUNGRY HOWIE

T-MOBILE SITE ID:

A2B2227A

DARCEL

252835000000023020

ADDRESS:


3024 SPIRIT LAKE DRIVE WINTER HAVEN, FL 33880

SHEET TITLE:

GRADING DETAILS

SHEET NUMBER:


C-3.1

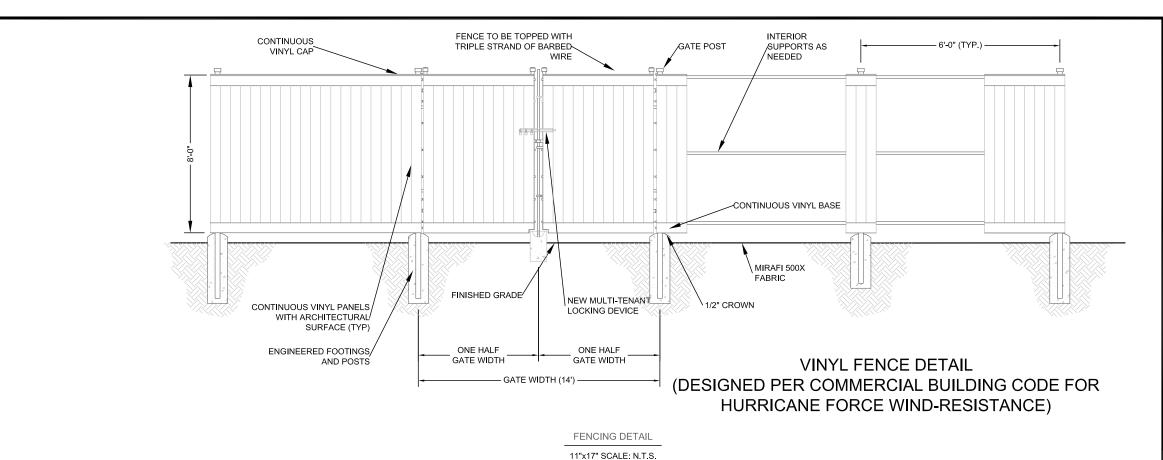



24"x36" SCALE: N.T.S.

NOTES:

- ALL FENCING TO BE INSTALLED PER ASTM F-567. ALL SWING GATES TO BE INSTALLED PER ASTM F-900.
- BARBED WIRE PERMIT REQUIRED SHALL BE COMPLETED IF LOCAL ORDINANCE REQUIRES.
- POST & GATE PIPE SIZES ARE INDUSTRY STANDARDS. ALL PIPE TO BE GALVANIZED (HOT DIP, ASTM A120 GRADE "A" STEEL). ALL GATE FRAMES SHALL BE WELDED. ALL WELDINGS SHALL BE COATED WITH (3) COATS OF GOLD GALV. (OR EQUAL). ALL OPEN POSTS SHALL HAVE END-CAPS.
- ALL SIGNS MUST BE MOUNTED ON INSIDE OF FENCE FABRIC USING
- MUSHROOM ANCHOR AND PLUNGER REQUIRED FOR GATE. GENERAL CONTRACTOR RESPONSIBLE FOR GATE LOCK.

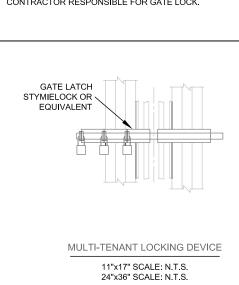

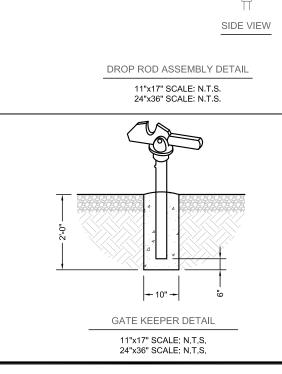


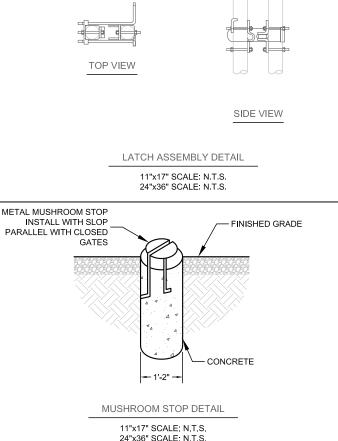

MULTILOCK INSTALLATION:

- DRILL 3/8" HOLES IN THE GATE LEAF USING THE GATE DIMENSIONS PROVIDED.
- SLIDE THE CARRIAGE BOLTS IN THE SLOTS ON THE BACK OF PART "B" AND PUSH THE BOLTS THROUGH THE HOLES DRILLED IN THE GATE FIGURE. PUT THE NUT AND THE LOCKNUT ON AND TIGHTEN AND CUT THE EXCESS BOLT OFF. DO THE SAME WITH PART "A"
- ADD THE NUMBER OF SLEEVES NEEDED FOR THE NUMBER OF LOCKS AND SLIDE THE LOCKING BAR INTO PLACE THROUGH BOTH PART "A" AND
- IF THE GATE HAS NO CENTER BAR IN THE GATE LEAF YOU MAY NEED TO MOUNT THE STYMIELOCK VERTICALLY USING THE SAME DIMENSIONS GIVEN ON THE GATE FACE
- VERTICAL APPLICATION MAY ALSO BE USED ON SLIDING GATES WITH

GATE LOCK ASSEMBLY:

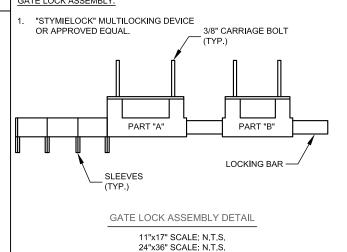

BTS II, LLC

750 PARK OF COMMERCE DR, SUITE 200 BOCA RATON, FL 33487





TAMPA FL 33634

FDH INFRASTRUCTURE SERVICES, LLC 6521 MERIDIEN DRIVE RALEIGH, NC 27616 PHONE: 919-755-1012 FAX: 919-755-1031


THE INFORMATION CONTAINED IN THIS SET OF DOCUMENTS IS PROPRIETARY BY NATURE DOCUMENTS IS PROPRIETARY BY NATURE.

REPRODUCTION OR CAUSING TO BE REPRODUCED

THE WHOLE OR ANY PART OF THESE DRAWINGS

WITHOUT THE PERMISSION OF FDH IS PROHIBITED.

SUBMITTALS						
REV	DATE	DESCRIPTION	BY	CHK'D		
0	03/17/2023	CONSTRUCTION	ZK	JRB		

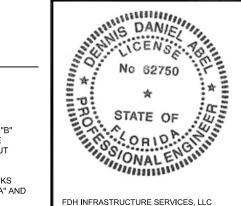

FDH INFRASTRUCTURE SERVICES, LLC DENNIS D. ABEL, PE STATE LICENNSE NO. 62750

FDH JOB NUMBER:

PR-008353

US-FL-7140

SITE NAME:

HUNGRY HOWIE

T-MOBILE SITE ID:

A2B2227A

252835000000023020


ADDRESS:


3024 SPIRIT LAKE DRIVE WINTER HAVEN, FL 33880

FENCE DETAILS

SHEET NUMBER:


C-4

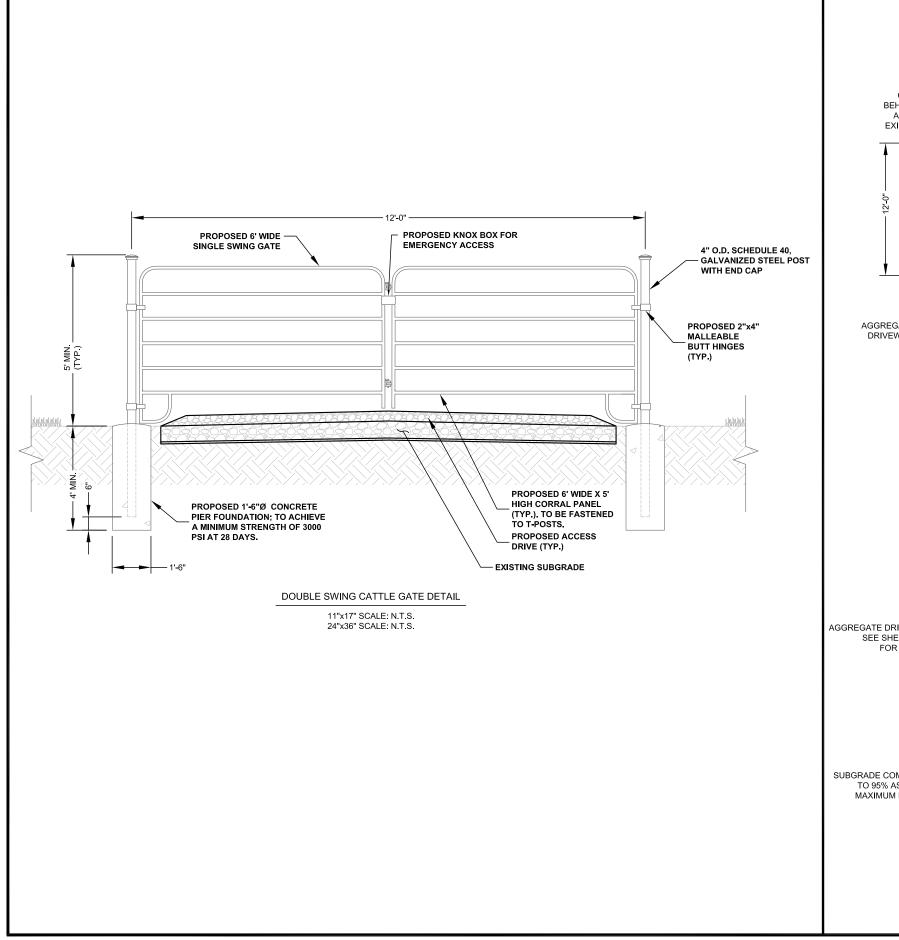

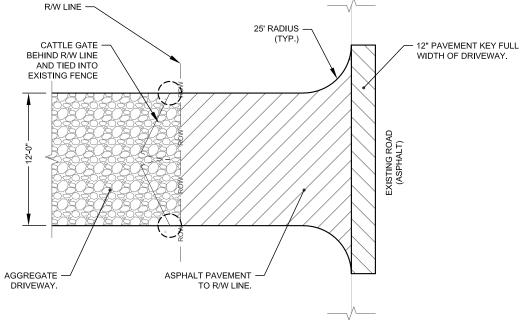

DRIVEWAY PLAN VIEW

11"x17" SCALE: N.T.S. 24"x36" SCALE: N.T.S.

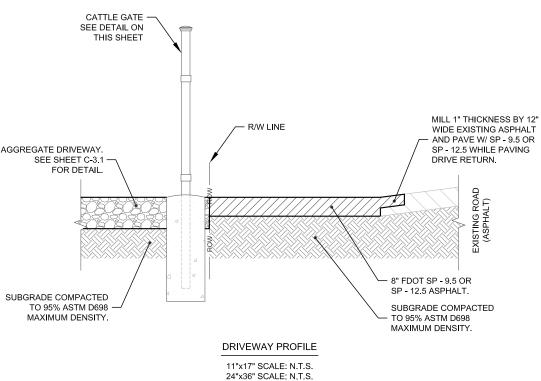

BTS II, LLC

750 PARK OF COMMERCE DR, SUITE 200 BOCA RATON, FL 33487



301 BENJAMIN CENTER L SUITE 110 A-B TAMPA, FL 33634




ENGINEERING INNOVATION

FDH INFRASTRUCTURE SERVICES, LLC 6521 MERIDIEN DRIVE RALEIGH, NC 27616 PHONE: 919-755-1012 FAX: 919-755-1031

THE INFORMATION CONTAINED IN THIS SET OF DOCUMENTS IS PROPRIETARY BY NATURE. REPRODUCTION OR CAUSING TO BE REPRODUCED THE WHOLE OR ANY PART OF THESE DRAWINGS WITHOUT THE PERMISSION OF FDH IS PROHIBITED.

SUBMITTALS

REV	DATE	DESCRIPTION	BY	CHK'D
0	03/17/2023	CONSTRUCTION	ZK	JRB

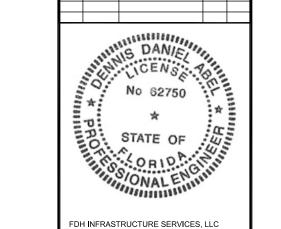

FDH INFRASTRUCTURE SERVICES, LLC DENNIS D. ABEL, PE STATE LICENNSE NO. 62750

FDH JOB NUMBER:

PR-008353

SITE ID:

US-FL-7140

SITE NAME: HUNGRY HOWIE

T-MOBILE SITE ID:

A2B2227A

, LDZZZ, ,

252835000000023020

ADDRESS:


3024 SPIRIT LAKE DRIVE WINTER HAVEN, FL 33880


SHEET TITLE:


CATTLE GATE & DRIVE WAY DETAILS

SHEET NUMBER:

C-4.1

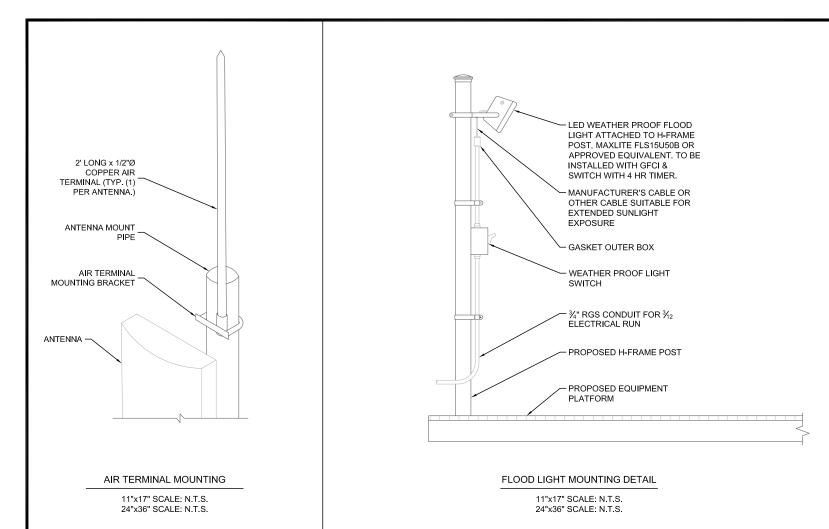

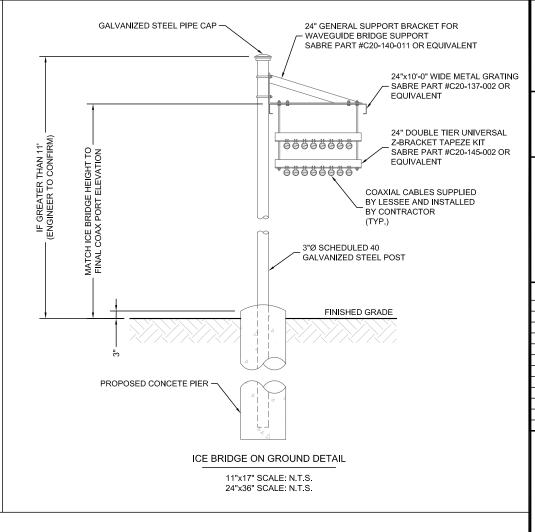

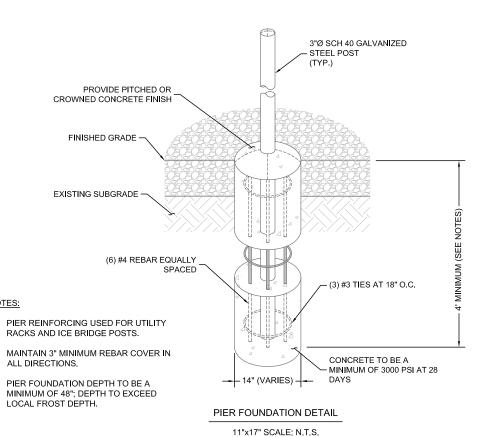


24"x36" SCALE: N.T.S.

GPS NOTES:

- 1. THE ELEVATION AND LOCATION OF THE GPS ANTENNA SHALL BE IN ACCORDANCE WITH THE FINAL RF REPORT.
- 2. THE GPS ANTENNA MOUNT IS DESIGNED TO FASTEN TO A STANDARD 1-1/4"Ø, SCHEDULE 40, GALVANIZED STEEL OR STAINLESS STEEL PIPE, THE PIPE MUST NOT BE THREADED AT THE ANTENNA MOUNT END, THE PIPE SHALL BE CUT TO THE REQUIRED LENGTH (MIN. 18") USING A HAND OR ROTARY PIPE CUTTER TO ASSURE A SMOOTH AND PERPENDICULAR CUT A HACK SAW SHALL NOT BE USED. THE CUT PIPE END SHALL E DEBURRED AND SMOOTH IN ORDER TO SEAL AGAINST THE NEOPRENE GASKET ATTACHED TO THE ANTENNA MOUNT.
- 3. IT IS CRITICAL THAT THE GPS ANTENNA IS MOUNTED SUCH THAT IT IS WITHIN 2° OF VERTICAL AND THE BASE OF THE ANTENNA IS WITHIN 2° LEVEL.

24"x36" SCALE: N.T.S.

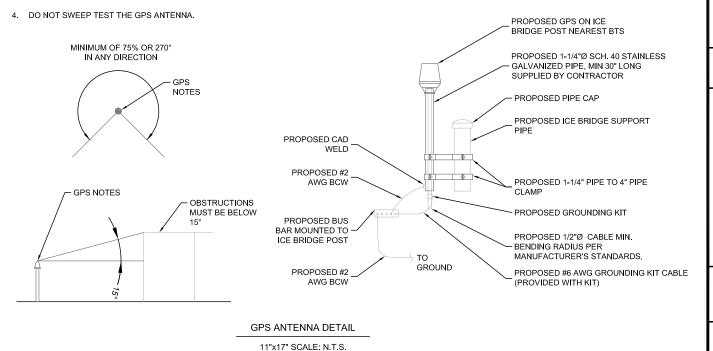

BTS II, LLC

750 PARK OF COMMERCE DR, SUITE 200 BOCA RATON, FL 33487



SUITE 110 A-B TAMPA, FL 33634



ENGINEERING INNOVATION
FDH INFRASTRUCTURE SERVICES, LLC

6521 MERIDIEN DRIVE RALEIGH, NC 27616
PHONE: 919-755-1012 FAX: 919-755-1031

THE INFORMATION CONTAINED IN THIS SET OF

DOCUMENTS IS PROPRIETARY BY NATURE.
REPRODUCTION OR CAUSING TO BE REPRODUCED
THE WHOLE OR ANY PART OF THESE DRAWINGS
WITHOUT THE PERMISSION OF FDH IS PROHIBITED.

SUBMITTALS						
DATE	DESCRIPTION	BY	CHK'D			
03/17/2023	CONSTRUCTION	ZK	JRB			



FDH INFRASTRUCTURE SERVICES, LLC DENNIS D. ABEL, PE STATE LICENNSE NO. 62750

FDH JOB NUMBER:

PR-008353

SITE ID:

US-FL-7140 SITE NAME:

HUNGRY HOWIE

T-MOBILE SITE ID:

A2B2227A

252835000000023020

ADDRESS:

3024 SPIRIT LAKE DRIVE WINTER HAVEN, FL 33880

SHEET TITLE:


PIER, GPS, & GROUND CONSTRUCTION DETAILS

SHEET NUMBER:

C-5

- 1. CONTRACTOR TO VERIFY MOUNTING SPECIFICATIONS WITH T-MOBILE PRIOR TO CONSTRUCTION.
- 2. ANCHOR BOLTS TO BE INSTALLED A MINIMUM OF 6" FROM EDGE OF CONCRETE PAD AND MIN. 4" EMBEDMENT.

ERICSSON P/N B160

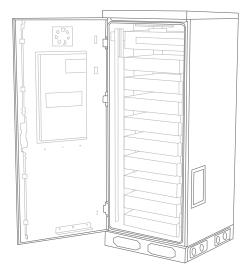


EQUIPMENT SPECIFICATIONS					
HEIGHT	63"				
WIDTH	25.6"				
DEPTH	27.6"				
WEIGHT	295 l bs				

B160 BATTERY CABINET DETAIL

11"x17" SCALE: N.T.S. 24"x36" SCALE: N.T.S.

PPC CABINET (VERTIV P/N CS7S2-W836 OR CLIENT APPROVED EQUIVALENT)

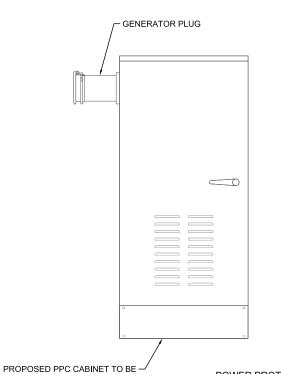

MOUNTED TO 1-5/8" UNISTRUT

FRAME AS REQUIRED.

GENERAL

CONSTRUCTION:

DIMENSIONS:

SINGLE LAYER ALUMINUM ENCLOSURE, NEMA TYPE 3R

66"X25"X10"

WEIGHT: ~150 LBS (WITHOUT PACKING)

FINISH: GRAY POWDER PAINT

DOOR LATCH: 3-POINT LATCHING

SAFETY:

UL 891 DEAD FRONT SWITCH BOARDS

OPERATING

TEMPERATURE:

HUMIDITY: NOT AVAILABLE

PROTECTION CLASS: NEMA TYPE 3R

NOT AVAILABLE

AC SECTION VOLT:

240/120Vac, SINGLE PHASE

CURRENT:

200A

AIC RATING:


UTILITY 65,000 AMPS

POWER PROTECTION CABINET (PPC)

11"x17" SCALE: N.T.S. 24"x36" SCALE: N.T.S.

- 1. CONTRACTOR TO VERIFY MOUNTING SPECIFICATIONS WITH T-MOBILE PRIOR TO CONSTRUCTION.
- 2. ANCHOR BOLTS TO BE INSTALLED A MINIMUM OF 6" FROM EDGE OF CONCRETE PAD AND MIN. 4" EMBEDMENT.

ERICSSON P/N E6160

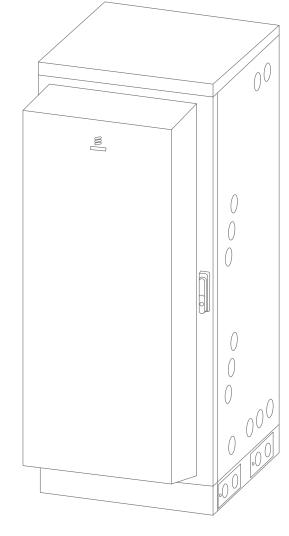

6160 SSC DETAIL	
11"x17" SCALE: N.T.S	

24"x36" SCALE: N.T.S.

	VB
BTS	II, LLC

750 PARK OF COMMERCE DR, SUITE 200 BOCA RATON, FL 33487





TAMPA, FL 33634

ENGINEERING INNOVATION

FDH INFRASTRUCTURE SERVICES, LLC 6521 MERIDIEN DRIVE RALEI GH, NC 27616 PHONE: 919-755-1012 FAX: 919-755-1031

THE INFORMATION CONTAINED IN THIS SET OF DOCUMENTS IS PROPRIETARY BY NATURE.
REPRODUCTION OR CAUSING TO BE REPRODUCED
THE WHOLE OR ANY PART OF THESE DRAWINGS
WITHOUT THE PERMISSION OF FDH IS PROHIBITED.

	SUBMITTALS									
EV	DATE	DESCRIPTION	BY	CHK'D						
0	03/17/2023	CONSTRUCTION	ZK	JRB						

EQUIPMENT SPECIFICATIONS

63"

25.6"

26"


380**l**bs

HEIGHT

WIDTH

DEPTH

WEIGHT

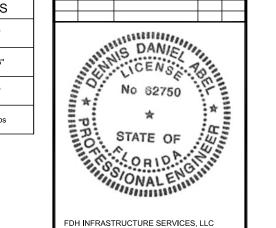

FDH INFRASTRUCTURE SERVICES, LLC DENNIS D. ABEL, PE STATE LICENNSE NO. 62750

FDH JOB NUMBER:

PR-008353

SITE ID:

US-FL-7140 SITE NAME:

HUNGRY HOWIE

T-MOBILE SITE ID:

A2B2227A

252835000000023020

ADDRESS:


3024 SPIRIT LAKE DRIVE WINTER HAVEN, FL 33880


SHEET TITLE:

T-MOBILE CABINET DETAILS

SHEET NUMBER:

C-5.1

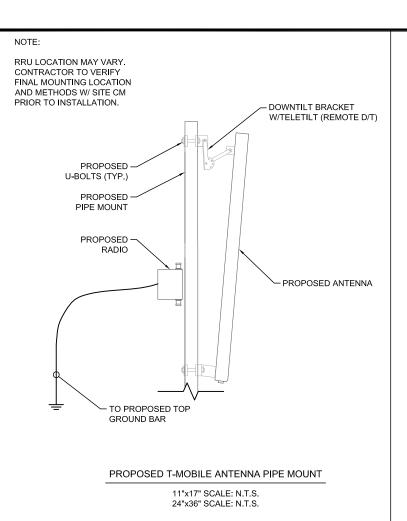

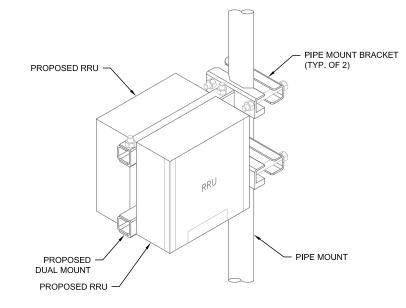


NOTES:

- RRU MANUFACTURER VIA AT&T SUPPLIES RRU, RRU PIPE-MOUNTING BRACKET. SUBCONTRACTOR SHALL SUPPLY PIPE AND INSTALL ALL MOUNTING HARDWARE INCLUDING RRU PIPE-MOUNTING BRACKET
- 2. FOR PIPE DIAMETERS FROM 6" TO 15", AT&T CAN SUPPLY A PAIR OF PIPE MOUNTING METAL BANDS WITH BOLTING WELDMENT.
- NO PAINTING OF THE RRU OR SOLAR SHIELD IS ALLOWED

DUAL RRU MOUNTING DETAIL

11"x17" SCALE: N.T.S. 24"x36" SCALE: N.T.S.

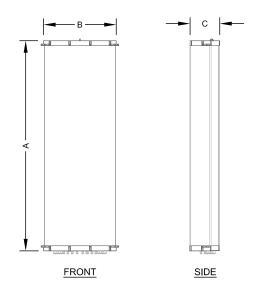

ANTENNA SPECIFICATIONS							
MODEL	LENGTH (A)	WIDTH (B)	DEPTH (C)	WEIGHT (lb)			
COMMSCOPE FFVV-65C-R3-V1 (OCTO)	95.9"	25.2"	9.3"	124.6			
AIR 6419 B41 MASSIVE MIMO	33.6"	20.0"	6.3"	68.5			

ANTENNA SPECIFICATIONS


11"x17" SCALE: N.T.S. 24"x36" SCALE: N.T.S.

EQUIPMENT NOTES:

- THIS ANTENNA ORIENTATION PLAN IS SCHEMATIC IN NATURE. THE CONTRACTOR SHALL VERIFY TOWER ORIENTATION AND FIELD COORDINATE REQUIRED ADJUSTMENTS TO ACHIEVE THE DESIRED ANTENNA AZIMUTHS.
- 2. THE HYBRID CABLE LENGTH SHOWN IS APPROXIMATE AND SHOULD NOT BE USED FOR ORDERING MATERIALS. CONFIRM THE REQUIRED HYBRID CABLE LENGTH WITH T-MOBILE PRIOR TO ORDERING OR INSTALLATION.

 3. ANTENNA CENTERLINE HEIGHT REFERENCED FROM
- 3. ANTENNA CENTERLINE HEIGHT REFERENCED FROM GROUND AT BASE OF TOWER, ASSUMING HEIGHT OF 0'-0" AT SAID REFERENCE POINT.
- ALL ANTENNAS, CABLES AND MOUNTS SHALL BE INSTALLED IN ACCORDANCE WITH THE TOWER ENGINEER'S RECOMMENDATIONS IN A MANNER CONSISTENT WITH THE STRUCTURAL ANALYSIS REPORT.
 ALL ANTENNA BRACKETS PER ANTENNA MANUFACTURER,
- ALL ANTENNA BRACKETS PER ANTENNA MANUFACTURES OR EQUAL. CONTRACTOR TO COORDINATE REQUIRED MECHANICAL DOWNTILT WITH T-MOBILE.
- 6. ALL ANTENNA INFORMATION TO BE CONFIRMED WITH T-MOBILE RF DESIGN PRIOR TO INSTALLATION

FINAL SECTOR ALPHA

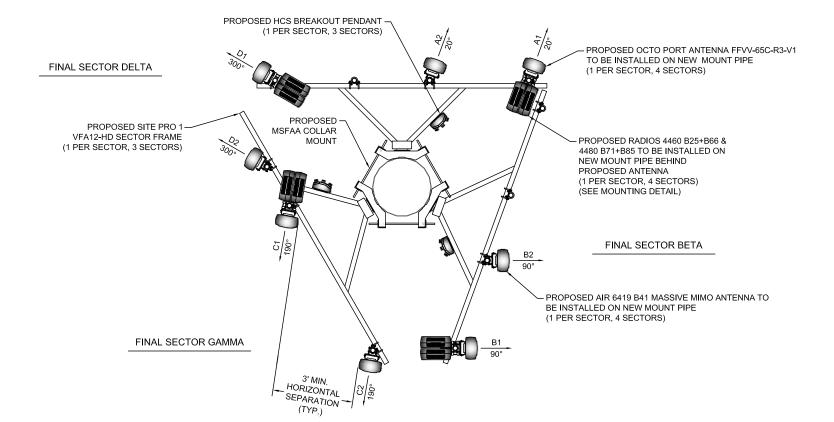

BTS II, LLC

750 PARK OF COMMERCE DR, SUITE 200 BOCA RATON, FL 33487



TAMPA, FL 33634




ENGINEERING INNOVATION
FDH INFRASTRUCTURE SERVICES, LLC

6521 MERIDIEN DRIVE RALEIGH, NC 27616 PHONE: 919-755-1012 FAX: 919-755-1031

THE INFORMATION CONTAINED IN THIS SET OF DOCUMENTS IS PROPRIETARY BY NATURE. REPRODUCTION OR CAUSING TO BE REPRODUCED THE WHOLE OR ANY PART OF THESE DRAWINGS WITHOUT THE PERMISSION OF FDH IS PROHIBITED.

	SUBMITTALS										
REV	DATE	DESCRIPTION	BY	CHK'							
0	03/17/2023	CONSTRUCTION	ZK	JRB							

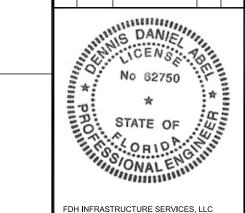

FDH INFRASTRUCTURE SERVICES, LLC DENNIS D. ABEL, PE STATE LICENNSE NO. 62750

FDH JOB NUMBER:

PR-008353

SITE ID:

US-FL-7140 SITE NAME:

HUNGRY HOWIE

T-MOBILE SITE ID: A2B2227A

, LDZZZ, ,

252835000000023020

ADDRESS:

3024 SPIRIT LAKE DRIVE WINTER HAVEN, FL 33880

SHEET TITLE:

T-MOBILE ANTENNA LAYOUT & DETAILS

SHEET NUMBER:


C-6

PROPOSED T-MOBILE ANTENNA CONFIGURATION

11"x17" SCALE: N.T.S. 24"x36" SCALE: N.T.S.

	ANTENNA KEY												
SECTOR	POSITION	ANTENNA MAKE & MODEL	TECHNOLOGY	ANTENNA AZIMUTH	M TILT	E TILT	ANTENNA CENTERLINE	RADIO EQUIP.	RADIO EQUIP.	BREAKOUT	CABLE TYPE	CABLE LENGTH	
ALPHA	A1	COMMSCOPE FFVV-65C-R3-V1(OCTO)	L700 N600/L2100 L1900/N1900	20°	0°	-	140'-0"	4480 B71+B85	4460 B25+B66				
	A2	AIR 6419 B41 ACTIVE ANTENNA-MASSIVE MIMO	N2500/L2500	20°	0°	-	140'-0"	-	-				
ВЕТА	В1	COMMSCOPE FFVV-65C-R3-V1(OCTO)	L700 N600/L2100 90° 0° - 140'-0" 4480 4460 L1900/N1900 90° - 140'-0" 871+B85 825+B66										
	B2	AIR 6419 B41 ACTIVE ANTENNA-MASSIVE MIMO	N2500/L2500	90°	0°	-	140'-0"	-	=	(3) HCS PENDANTS	(3) HCS 2.0 CABLES	210'-0"±	
GAMMA	C1	COMMSCOPE FFVV-65C-R3-V1(OCTO)	L700 N600/L2100 L1900/N1900	190°	0°	-	140'-0"	4480 B71+B85	4460 B25+B66				
	C2	AIR 6419 B41 ACTIVE ANTENNA-MASSIVE MIMO	N2500/L2500	190°	0°	-	140'-0"	-	-				
DELTA	D1	COMMSCOPE FFVV-65C-R3-V1(OCTO)	L700 N600/L2100 L1900/N1900	300°	0°	-	140'-0"	4480 B71+B85	4460 B25+B66				
	D2	AIR 6419 B41 ACTIVE ANTENNA-MASSIVE MIMO	N2500/L2500	300°	0°	-	140'-0"	-	-				

PROPOSED ANTENNA SCHEDULE

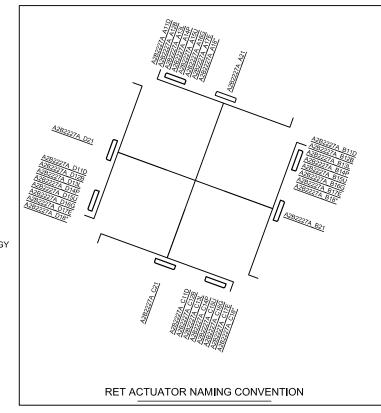

EQUIPMENT NOTES:

- 1. ANTENNA CONTRACTOR SHALL ENSURE THAT ALL ANTENNA MOUNTING PIPES ARE PLUMB.
- 2. COAXIAL FEEDER & FIBER LENGTHS INDICATED ARE APPROXIMATE.
- ANTENNA COAXIAL FEEDERS & ANTENNA JUMPERS SHALL BE COLOR CODED PER T-MOBILE REQUIREMENTS, IN THE ANTENNA KEY THE FOLLOWING CHECKER STRIPE SHALL BE ADDED TO EACH ANTENNA COAXIAL FEEDER & ANTENNA JUMPER.

LTE 700 - WHITE-ORANGE
LTE PCS - ORANGE-ORANGE
LTE AWS - N/A
UMTS PCS - ORANGE-BLUE
UMTS AWS - N/A
GSM PCS - ORANGE-WHITE
LTE 600 - PINK-ORANGE

 IN ADDITION TO THE COLOR CODE THE FOLLOWING ANTENNA SECTOR COLOR STRIPE SHALL BE ADDED TO EACH ANTENNA SECTOR FEEDER & JUMPER.

> ALPHA - RED BETA - GREEN GAMMA - BLUE DELTA - YELLOW EPSILON - WHITE ZETA - PURPLE

- 5. MULTI PORT ANTENNAS: TERMINATE UNUSED ANTENNA PORTS WITH CONNECTOR CAP & WEATHERPROOF THOROUGHLY. JUMPERS FROM TMA'S MUST TERMINATE TO OPPOSITE POLARIZATIONS IN EACH SECTOR.
- CONTRACTOR MUST FOLLOW ALL MANUFACTURERS' RECOMMENDATIONS REGARDING THE INSTALLATION OF COAXIAL CABLE, CONNECTORS, AND ANTENNAS
- 7. MINIMUM BEND RADIUS:

LDF4-50A (1/2" HARD LINE)=5" FSJ4-50B (1/2" SUPER FLEX)=1-1/4" AVA5-50A (7/8" HARD LINE)=10" AVA7-50A (1-5/8" HARD LINE)=15" LDF7-50A (1-5/8" HARD LINE)=20"

- 8. CONTRACTOR SHALL RECORD THE SERIAL #, SECTOR, AND POSITION OF EACH ACTUATOR INSTALLED AT THE ANTENNAS AND FURNISH THE INFORMATION TO T-MOBILE.
- WEATHERPROOF ALL ANTENNA CONNECTORS WITH SELF AMALGAMATING TAPE.
- 10. ANTENNA CONTRACTOR SHALL PERFORM A "TAPE DROP MEASUREMENT TO CONFIRM/VALIDATE ANTENNA CENTERLINE (ACL.) HEIGHT. CONTRACTOR SHALL SUBMIT A COMPLETED HEIGHT VERIFICATION FORM TO THE CONTRACTION MANGER.
- 11. ALL FIBER RUNS CONTAINED IN ONE COMMSCOPE HYBRID DC-FIBER CABLE (MODEL# ASU9325TYP01) FROM LOWER COVP TO UPPER COVP. HYBRID CABLE SHALL BE COLOR CODED PER T-MOBILE REQUIREMENTS.
- 12. HYBRID CABLE HYBRIFLEX 6x24 4AWG
- 13. ALL ANTENNA INFORMATION TO BE CONFIRMED WITH T-MOBILE RF DESIGN PRIOR TO INSTALLATION

EQUIPMENT KEY SECTOR								
LOCATION	VENDOR	EQUIPMENT	MODEL NO.	QTY. & STATUS				
LOCATION	VENDOR	DOR EQUIPMENT MODELING.		EXISTING	NEW			
1 PER SECTOR	ERICSSON	RRU	RADIO 4480 B71+B85	-	4			
1 PER SECTOR	ERICSSON	RRU	RADIO 4460 B25+B66	-	4			
MOUNT FRAME	COMMSCOPE	PENDANT	HCS	-	3			

BTS II, LLC

750 PARK OF COMMERCE DR, SUITE 200 BOCA RATON, FL 33487






FDH INFRASTRUCTURE SERVICES, LLC
6521 MERIDIEN DRIVE RALEIGH, NC 27616
PHONE: 919-755-1012 FAX: 919-755-1031

THE INFORMATION CONTAINED IN THIS SET OF DOCUMENTS IS PROPRIETARY BY NATURE, REPRODUCTION OR CAUSING TO BE REPRODUCED THE WHOLE OR ANY PART OF THESE DRAWINGS WITHOUT THE PERMISSION OF FOH IS PROHIBITED.

SUBMITTALS								
REV	DATE	DESCRIPTION	BY	CHKI				
0	03/17/2023	CONSTRUCTION	ZK	JRB				

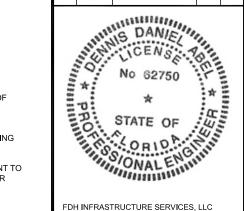

FDH INFRASTRUCTURE SERVICES, LLC DENNIS D. ABEL, PE STATE LICENNSE NO. 62750

FDH JOB NUMBER:

PR-008353

SITE ID:

US-FL-7140

HUNGRY HOWIE

T-MOBILE SITE ID:

A2B2227A

252835000000023020


3024 SPIRIT LAKE DRIVE WINTER HAVEN, FL 33880


SHEET TITLE:

T-MOBILE ANTENNA LAYOUT & DETAILS

SHEET NUMBER

C-6.1

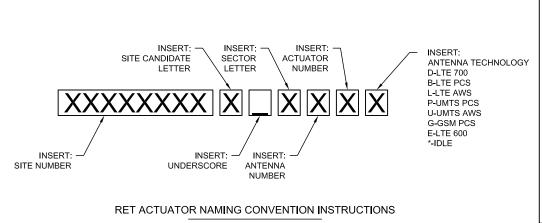

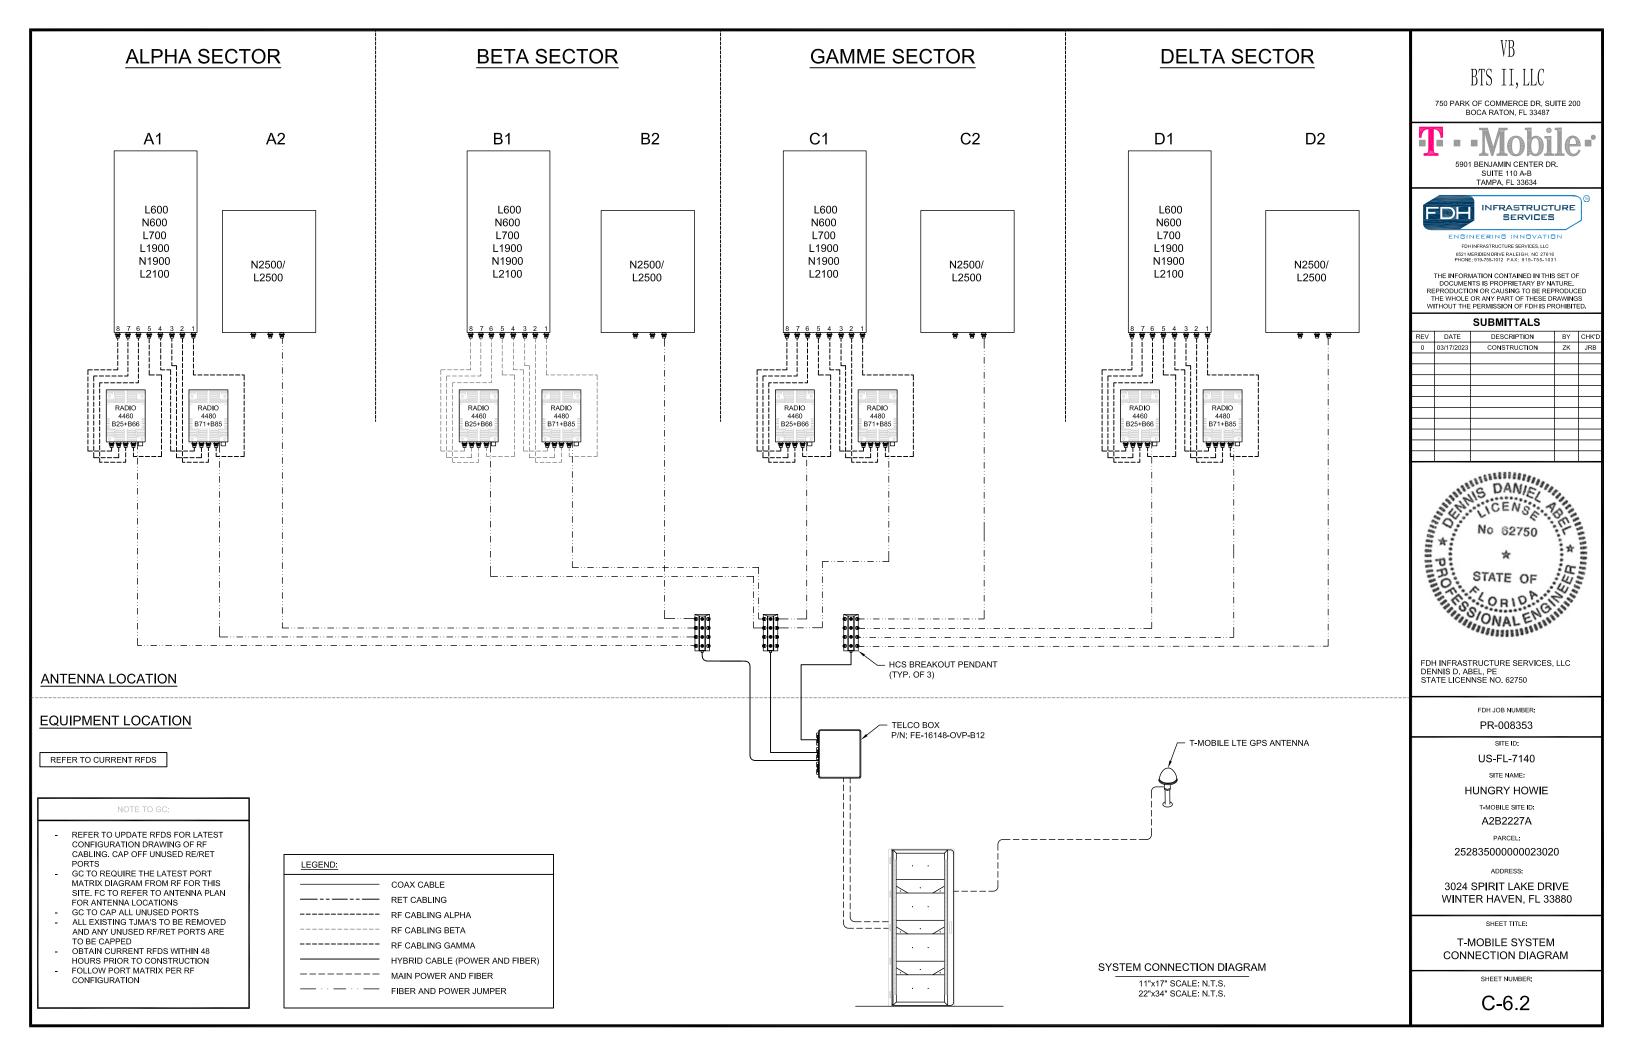



CONTRACTOR TO INSTALL NUMBERED MULE-TAPE IN ALL CONDUITS.

NOTE: THIS SITE IS PARTIALLY LOCATED IN FLOOD ZONE AE 134.3, NAVD '88. SITE TOPOGRAPHY IS ALSO ON NAVD '88. ALL EQUIPMENT SHALL BE ELEVATED TO A MINIMUM ELEVATION OF 135.5'.

— OHP — E-OVERHEAD POWER

E-CHAINLINK FENCE

E-EASEMENT

E-RIGHT OF WAY

E-MINOR CONTOUR

P-MINOR CONTOUR

P-LEASE AREA

— — E-MAJOR CONTOUR

E-ROAD — P-ROAD


— — — P-MAJOR CONTOUR

— – – P-PROPERTY LINE

- X ----- X ---- P-FENCE

— — — P-EASEMENT

---- ROW ------

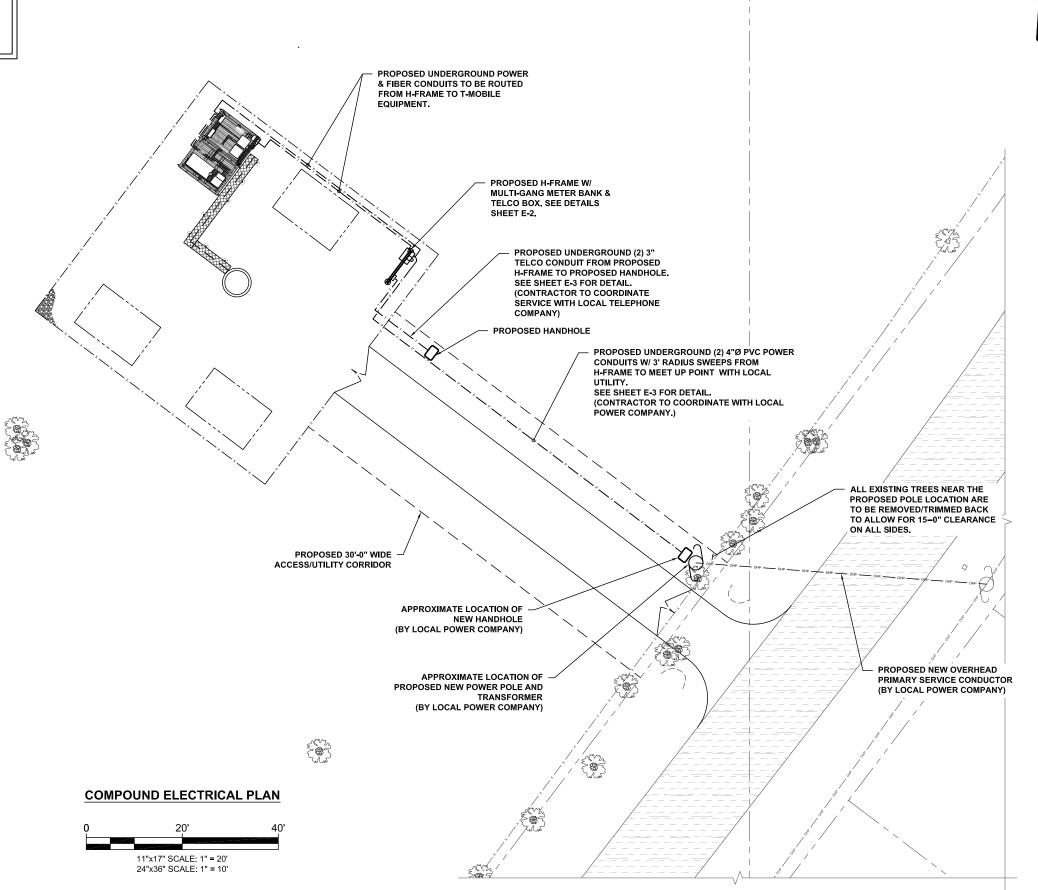

750 PARK OF COMMERCE DR, SUITE 200



BOCA RATON, FL 33487

SUITE 110 A-B TAMPA, FL 33634




ENGINEERING INNOVATION FDH INFRASTRUCTURE SERVICES, LLC

THE INFORMATION CONTAINED IN THIS SET OF

DOCUMENTS IS PROPRIETARY BY NATURE. REPRODUCTION OR CAUSING TO BE REPRODUCED THE WHOLE OR ANY PART OF THESE DRAWINGS WITHOUT THE PERMISSION OF FDH IS PROHIBITED. SUBMITTALS

	00Biii[117420										
REV	DATE	DESCRIPTION	BY	CHK'D							
0	03/17/2023	CONSTRUCTION	ZK	JRB							

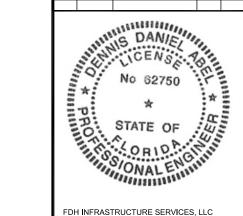

FDH INFRASTRUCTURE SERVICES, LLC DENNIS D. ABEL, PE STATE LICENNSE NO. 62750

FDH JOB NUMBER:

PR-008353

SITE ID:

US-FL-7140 SITE NAME:

HUNGRY HOWIE

T-MOBILE SITE ID:

A2B2227A

252835000000023020


ADDRESS:

3024 SPIRIT LAKE DRIVE WINTER HAVEN, FL 33880

COMPOUND ELECTRICAL PLAN

SHEET NUMBER:

E-1

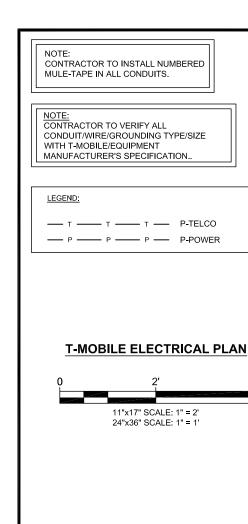

CALLOUTS:

- (1) PROPOSED UNDERGROUND (1) 3"Ø PVC TELCO SCHEDULE 40 CONDUIT FROM PROPOSED TELCO STUB UP TO PROPOSED CARRIER EQUIPMENT
- 2 PROPOSED UNDERGROUND (1) 3"Ø PVC SCHEDULE 40 POWER CONDUIT FROM PROPOSED METER BANK TO PROPOSED CARRIER
- (3) PROPOSED AUTOMATIC TRANSFER SWITCH.
- (1) PROPOSED 2"Ø POWER CONDUIT FROM PROPOSED ATS TO PROPOSED PPC.
- (1) PROPOSED 2"Ø CONDUIT FROM PROPOSED ATS TO PROPOSED PPC.
- (6) PROPOSED CARRIER BBU CABINET.
- 7 PROPOSED CARRIER SITE SUPPORT EQUIPMENT CABINET.
- (8) PROPOSED CARRIER PPC POWER CABINET.

- (9) PROPOSED CARRIER TELCO BOX
- (10) PROPOSED GPS ANTENNA.

PROPOSED ICE BRIDGE.

> 11) PROPOSED 3"Ø PVC CONDUIT FOR POWER FROM PPC CABINET TO SITE SUPPORT CABINET. CONTRACTOR TO VERIFY LOCATION.

0

0

0 0 0 0 0

0

- 12 PROPOSED (1) HIGH CAP HYBRID CABLE TO BE ROUTED UP TOWER TO HCS 2.0 BREAKOUT.
- PROPOSED (2) 2"Ø CONDUIT FROM PROPOSED BATTERY CABINET TO PROPOSED SITE SUPPORT CABINET FOR DC POWER
- 14) PROPOSED 2"Ø CONDUIT FROM PROPOSED SITE SUPPORT CABINET TO PROPOSED BATTERY CABINET FOR BATTERY HEATER.
- PROPOSED 2"Ø CONDUIT FROM ALARM TO PROPOSED SITE SUPPORT CABINET.

PROPOSED CARRIER MODULES RADIO/EMHA EQUIPMENT.

Φ /-(23)

0 0 0 0

0

- (17) PROPOSED 2"Ø CONDUITS FOR POWER FROM SITE SUPPORT CABINET TO OVP. (TYP.)
- (18) PURPOSELY OMMITED.

③

(26)

- (19) PROPOSED JUMPER FROM FCOA TO COVP. (TYP.) (26) PROPOSED GENERATOR.
- (20) PROPOSED COMMSCOPE OVP
- PROPOSED 1"Ø CONDUIT FOR DC POWER FROM TEL CO BOX TO SITE SUPPORT CARBUTE TELCO BOX TO SITE SUPPORT CABINET.
- (1) PROPOSED 2"Ø POWER CONDUIT FROM PROPOSED ATS TO PROPOSED GENERATOR.
- (1) PROPOSED 1"Ø REMOTE START W/ RELAY CONDUIT FROM PROPOSED ATS TO PROPOSED GENERATOR.

(1) PROPOSED 1"Ø ALARM CONDUIT FROM PROPOSED GENERATOR TO PROPOSED SITE SUPPORT CABINET

(6)

-(24)

- (1) PROPOSED 1"Ø HEATER BLOCK & BATTERY (1) PROPOSED TO HEATER BESSEL CHARGER CONDUIT FROM PROPOSED GENERATOR TO PROPOSED SITE SUPPORT

750 PARK OF COMMERCE DR, SUITE 200 BOCA RATON, FL 33487

BTS II, LLC





TAMPA, FL 33634

ENGINEERING INNOVATION

FDH INFRASTRUCTURE SERVICES, LLC

THE INFORMATION CONTAINED IN THIS SET OF DOCUMENTS IS PROPRIETARY BY NATURE DOCUMENTS IS PROPRIETARY BY NATURE.

REPRODUCTION OR CAUSING TO BE REPRODUCED

THE WHOLE OR ANY PART OF THESE DRAWINGS

WITHOUT THE PERMISSION OF FDH IS PROHIBITED.

SUBMITTALS

REV	DATE	DESCRIPTION	BY	СНК
0	03/17/2023	CONSTRUCTION	ZK	JRE

SEE SHEET E-3 FOR

SEE SHEET E-3 FOR

DETAIL.

DETAIL.

|⊙|

(20)

16

 $\overline{7}$

<u>\</u>21)



FDH INFRASTRUCTURE SERVICES, LLC DENNIS D. ABEL, PE STATE LICENNSE NO. 62750

FDH JOB NUMBER:

PR-008353

SITE ID: US-FL-7140

SITE NAME:

HUNGRY HOWIE

T-MOBILE SITE ID:

A2B2227A

252835000000023020

ADDRESS:


3024 SPIRIT LAKE DRIVE WINTER HAVEN, FL 33880

SHEET TITLE:

T-MOBILE EQUIPMENT ELECTRICAL PLAN

SHEET NUMBER:

E-1.1

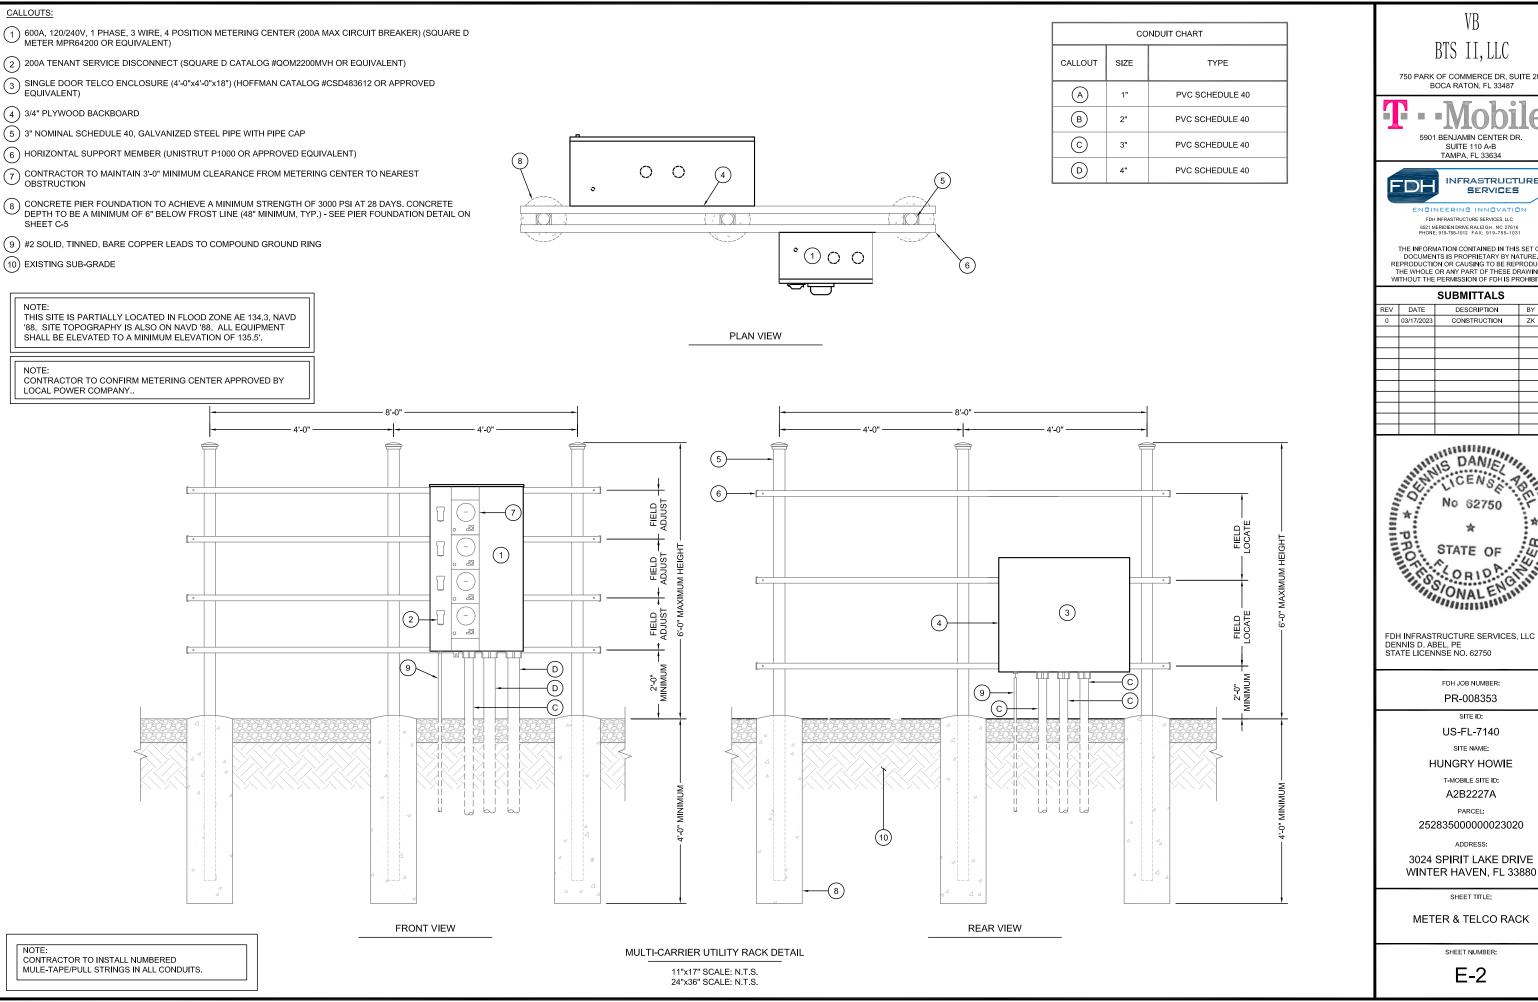

BTS II, LLC

750 PARK OF COMMERCE DR, SUITE 200






FDH INFRASTRUCTURE SERVICES, LLC

THE INFORMATION CONTAINED IN THIS SET OF DOCUMENTS IS PROPRIETARY BY NATURE.
REPRODUCTION OR CAUSING TO BE REPRODUCED
THE WHOLE OR ANY PART OF THESE DRAWINGS
WITHOUT THE PERMISSION OF FDH IS PROHIBITED.

	SUBMITTALS										
REV	DATE	DESCRIPTION	BY	СНК							
0	03/17/2023	CONSTRUCTION	ZK	JRE							
		· ·									

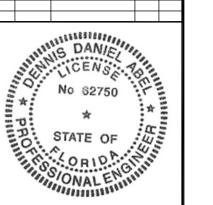

DENNIS D. ABEL, PE STATE LICENNSE NO. 62750

FDH JOB NUMBER:

PR-008353

SITE NAME:

HUNGRY HOWIE

252835000000023020

ADDRESS:


3024 SPIRIT LAKE DRIVE WINTER HAVEN, FL 33880

SHEET TITLE:

METER & TELCO RACK

SHEET NUMBER:

E-2

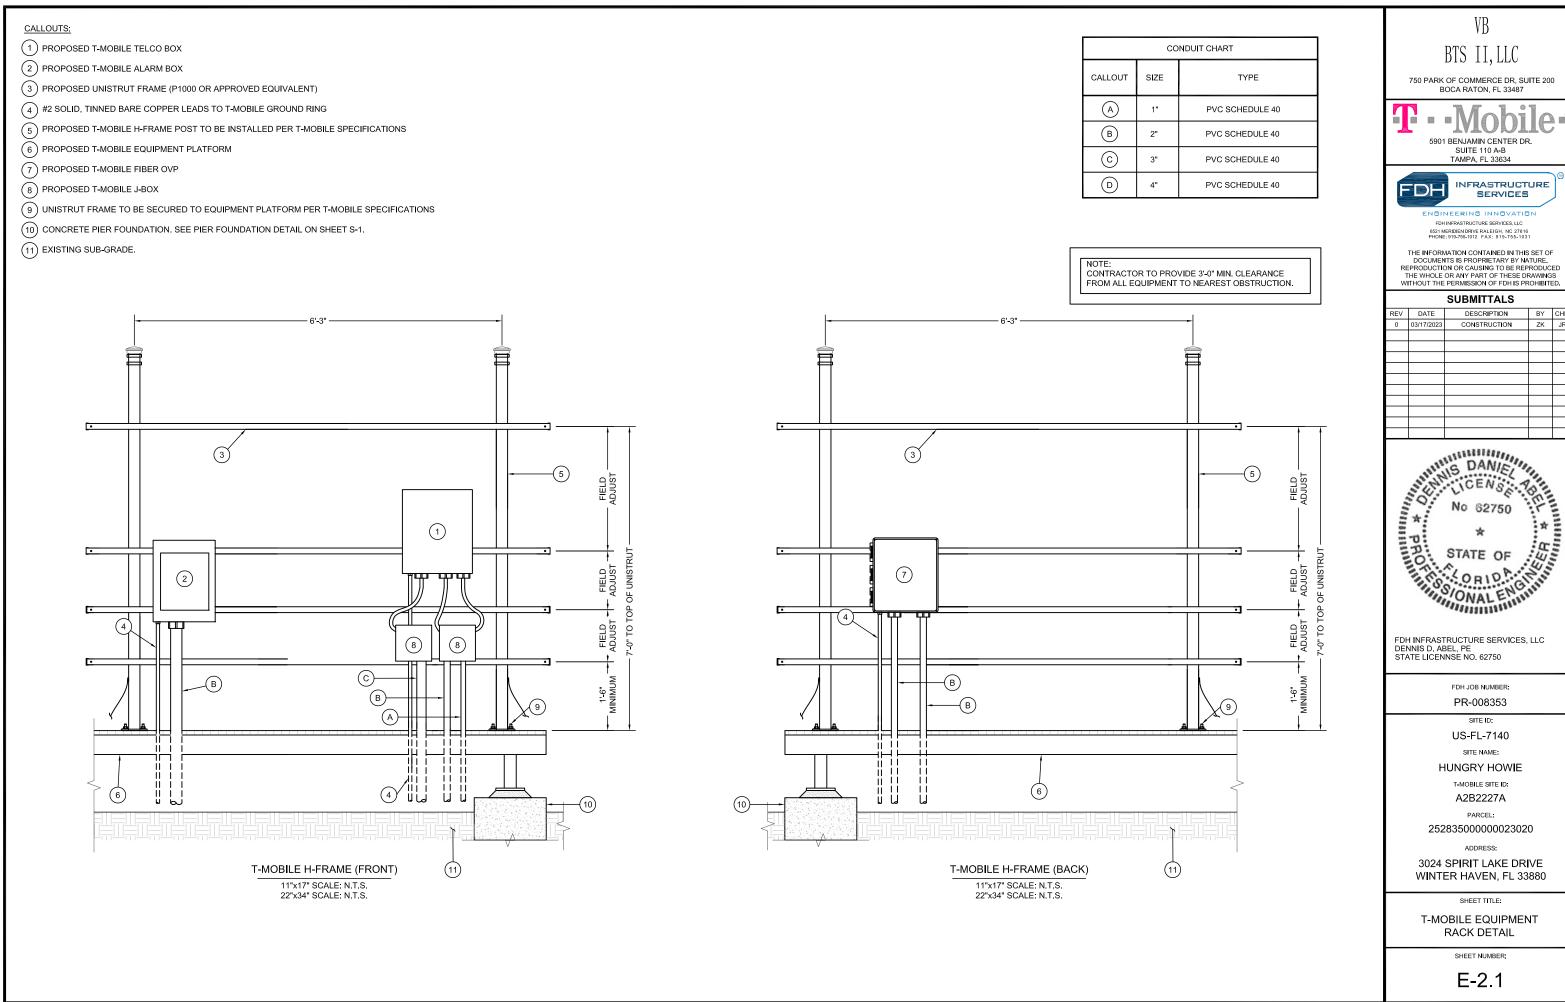





THE INFORMATION CONTAINED IN THIS SET OF


REV	DATE	DESCRIPTION	BY	CHK'D
0	03/17/2023	CONSTRUCTION	ZK	JRB



WINTER HAVEN, FL 33880

CALLOUTS:

- (1) PROPOSED T-MOBILE PPC POWER CABINET
- (2) PROPOSED T-MOBILE AUTOMATIC TRANSFER SWITCH
- (3) PROPOSED UNISTRUT FRAME (P1000 OR APPROVED EQUIVALENT)
- (4) #2 SOLID, TINNED BARE COPPER LEADS TO T-MOBILE GROUND RING
- (5) 1"Ø RIGID METAL CONDUIT FROM PPC CABINET TO GFCI RECEPTACLE/SWITCH
- (6) 20A OUTDOOR GFCI RECEPTACLE/SWITCH
- (7) 1"Ø RIGID METAL CONDUIT FROM GFCI RECEPTACLE/SWITCH TO OVER HEAD WORK LIGHTS
- (8) PROPOSED T-MOBILE H-FRAME POST TO BE INSTALLED PER T-MOBILE SPECIFICATIONS
- 9 PROPOSED T-MOBILE EQUIPMENT PLATFORM
- (10) UNISTRUT FRAME TO BE SECURED TO EQUIPMENT PLATFORM PER T-MOBILE SPECIFICATIONS
- (11) LED WEATHER PROOF FLOOD LIGHT ATTACHED TO POST.
- (12) CONCRETE PIER FOUNDATION. SEE PIER FOUNDATION DETAIL ON SHEET S-1.
- (13) EXISTING SUB-GRADE.

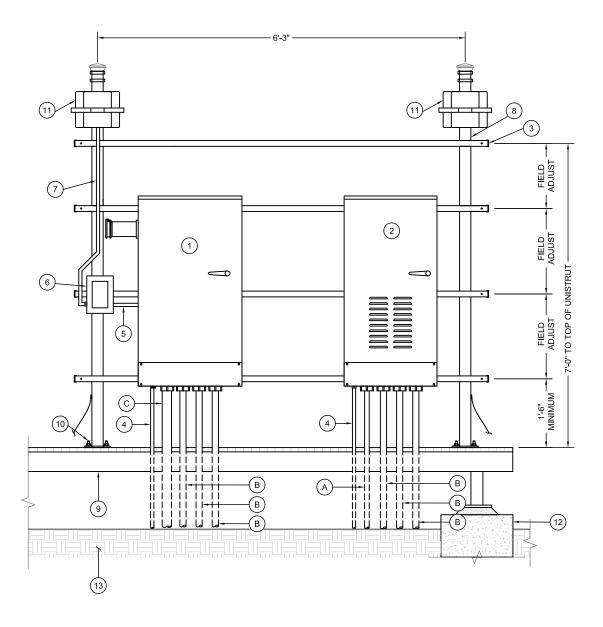

CONDUIT CHART				
CALLOUT SIZE		TYPE		
A	1"	PVC SCHEDULE 40		
В	2"	PVC SCHEDULE 40		
0	3"	PVC SCHEDULE 40		
D	4"	PVC SCHEDULE 40		

CONTRACTOR TO PROVIDE 3'-0" MIN, CLEARANCE FROM ALL EQUIPMENT TO NEAREST OBSTRUCTION. INFRASTRUCTURE SERVICES

BTS II, LLC

750 PARK OF COMMERCE DR, SUITE 200

BOCA RATON, FL 33487


5901 BENJAMIN CENTER DR.

SUITE 110 A-B TAMPA, FL 33634

ENGINEERING INNOVATION FDH INFRASTRUCTURE SERVICES, LLC 6521 MERIDIEN DRIVE RALEIGH, NC 27616 PHONE: 919-755-1012 FAX: 919-755-1031

THE INFORMATION CONTAINED IN THIS SET OF DOCUMENTS IS PROPRIETARY BY NATURE.
REPRODUCTION OR CAUSING TO BE REPRODUCED
THE WHOLE OR ANY PART OF THESE DRAWINGS
WITHOUT THE PERMISSION OF FDH IS PROHIBITED.

SUBMITTALS						
REV	DATE	DESCRIPTION	BY	CHK'D		
0	03/17/2023	CONSTRUCTION	ZK	JRB		

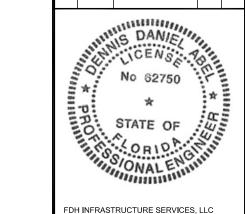

FDH INFRASTRUCTURE SERVICES, LLC DENNIS D. ABEL, PE STATE LICENNSE NO. 62750

FDH JOB NUMBER:

PR-008353

US-FL-7140

SITE NAME:

HUNGRY HOWIE T-MOBILE SITE ID:

A2B2227A

252835000000023020

ADDRESS:


3024 SPIRIT LAKE DRIVE WINTER HAVEN, FL 33880

SHEET TITLE:


T-MOBILE EQUIPMENT RACK DETAIL

SHEET NUMBER:

E-2.2

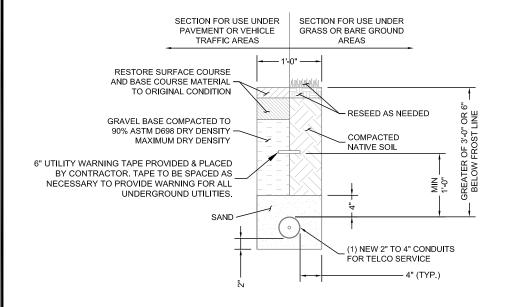

NOTE: CONTRACTOR TO INSTALL NUMBERED MULE-TAPE IN ALL CONDUITS.

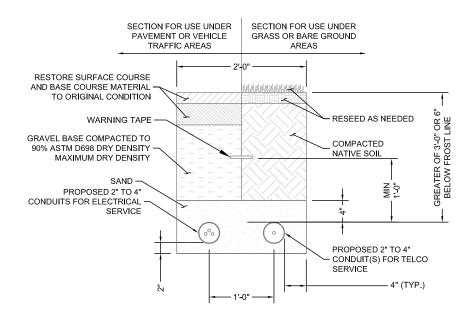

TELCO TRENCH DETAIL

11"x17" SCALE: N.T.S. 24"x36" SCALE: N.T.S.


JOINT UTILITY TRENCH DETAIL

11"x17" SCALE: N.T.S. 24"x36" SCALE: N.T.S.

ALL CONDUIT TRENCHING, COVER, HORIZONTAL CLEARANCE, AND BACKFILL REQUIREMENTS SHALL BE PROVIDED AS NECESSARY TO MEET OR EXCEED THE GOVERNING CODE OR MANUFACTURER'S INSTALLATION REQUIREMENTS, WHICHEVER IS MORE STRINGENT.

- 1. ACTUAL SEPARATION OF CONDUITS TO BE DETERMINED BY SITE SPECIFIC REQUIREMENTS
- 2. UNDERGROUND CONDUIT TRENCH TO BE LOCATED AS CLOSE TO COMPOUND FENCE AS POSSIBLE WITHOUT COMPROMISING THE INTEGRITY OF THE FENCE.
- 3. PROVIDE PVC CONDUIT BELOW GRADE EXCEPT AS NOTED BELOW.
- 4. PROVIDE RGS CONDUIT AND ELBOWS AT STUB-UP LOCATIONS (I.E. SERVICE POLES, EQUIPMENT, ETC.).



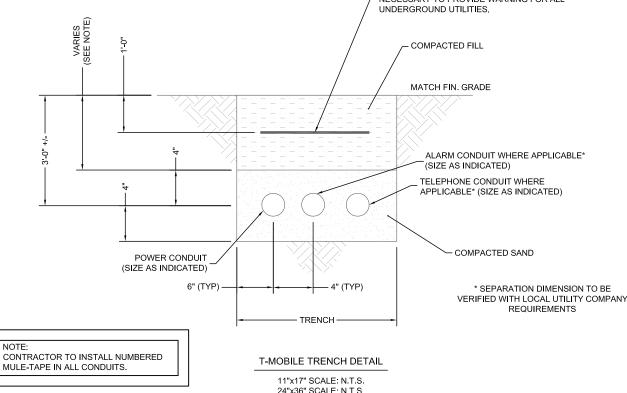

SUMMARY OF ELECTRIC SERVICE CONSTRUCTIONS RESPONSIBILITIES

TECO: TEENA SIMPSON, 813-630-7280, TNDAMPIER@TECOENERGY.COM

- WILL SUPPLY AND INSTALL NEW DROP POLE WITHIN VB BTS ACCESS & UTILITY EASEMENT.
 WILL SUPPLY AND INSTALL NEW TRANSFORMER ON DROP POLE.
- WILL SUPPLY AND INSTALL NEW HANDHOLE AT BASE OF NEW DROP POLE.
- WILL SUPPLY AND INSTALL NEW CONDUCTOR FOR THE OVERHEAD PRIMARY SERVICE EXTENSION FROM TAKE-OFF POINT TO THE NEW TRANSFORMER.
- WILL SUPPLY AND INSTALL NEW CONDUCTOR FOR THE SECONDARY SERVICE EXTENSION FROM THE NEW
- TRANSFORMER TO THE NEW HANDHOLE.
- WILL SUPPLY AND INSTALL METERS.

VB BTS:

- ASSIST IN GETTING TECO'S NEEDED EASEMENT SIGNED BY PROPERTY OWNER.
- SUPPLY AND INSTALL CONDUIT AND CONDUCTOR FOR UNDERGROUND SECONDARY SERVICE FROM THE NEW HANDHOLE AT THE BASE OF THE NEW DROP POLE TO THE METER BANK.
 - O CONDUIT RECOMMENDED IS TWO (2) SETS OF 4-INCH SCHEDULE 40 PVC WITH LARGE RADIUS (3-FEET) SCHEDULE 80 SWEEPS AT THE TRANSFORMER AND H-FRAME. ANY ABOVE GROUND CONDUIT NEEDS TO BE
 - O CONDUIT TO BE BURIED A MINIMUM OF 24 TO 30-INCHES IN DEPTH.
 - O CONDUCTOR RECOMMENDED IS TWO (2) SETS (ONE PER CONDUIT) OF THREE (3) 350-KCMIL COPPER XHHW **FEEDERS**
 - O CONFIRM DEPTH REQUIRED WITH LOCAL JURISDICTION.
- SUPPLY AND INSTALL NEW METER-BANK.
- INSURE METER-BANK IS TECO-APPROVED. SEE APPROVED LIST ON TECO'S APPROVED METER EQUIPMENT ENCLOSURE LIST PROVIDED IN THE UTILITY COORDINATION REPORT
 • INSURE INSTALLATION MEETS TECO'S STANDARD ELECTRIC SERVICE REQUIREMENTS.
- OBTAIN ALL REQUIRED ELECTRICAL PERMITS.
- . COORDINATE ALL INSPECTIONS.

BTS II, LLC

750 PARK OF COMMERCE DR, SUITE 200 BOCA RATON, FL 33487




TAMPA FL 33634



ENGINEERING INNOVATION FDH INFRASTRUCTURE SERVICES, LLC 6521 MERIDIEN DRIVE RALEIGH, NC 27616 PHONE: 919-755-1012 FAX: 919-755-1031

THE INFORMATION CONTAINED IN THIS SET OF DOCUMENTS IS PROPRIETARY BY NATURE. REPRODUCTION OR CAUSING TO BE REPRODUCED THE WHOLE OR ANY PART OF THESE DRAWINGS
WITHOUT THE PERMISSION OF FDH IS PROHIBITED.

SUBMITTALS						
REV	DATE	DESCRIPTION	BY	CHK'		
0	03/17/2023	CONSTRUCTION	ZK	JRB		

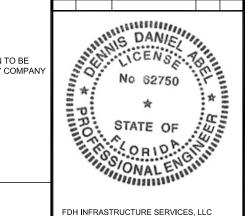

FDH INFRASTRUCTURE SERVICES, LLC DENNIS D. ABEL, PE STATE LICENNSE NO. 62750

FDH JOB NUMBER:

PR-008353

SITE ID:

US-FL-7140 SITE NAME:

HUNGRY HOWIE

T-MOBILE SITE ID:

A2B2227A

252835000000023020

ADDRESS:

3024 SPIRIT LAKE DRIVE WINTER HAVEN, FL 33880

SHEET TITLE:


ELECTRICAL DETAILS


SHEET NUMBER:

E-3



- 1. ELECTRICAL SERVICE SHALL BE 120/240V, 1Ø, 3W, 200A
- 2. PROVIDE SERVICE ENTRANCE RATED CIRCUIT BREAKER TYPE DISCONNECT SWITCH.
- FOR ALL WIRING, CONTRACTOR SHALL VERIFY CONDUCTOR WIRE/GROUND SIZE/TYPE AND CONDUIT SIZES WITH EQUIPMENT MANUFACTURERS SPECIFICATIONS AND THE NATIONAL ELECTRICAL CODE.
- 4. ALL EQUIPMENT SHALL MEET OR EXCEED FAULT CURRENT STANDARDS PER NEC 110.9.
- ALL ELECTRICAL WORK SHALL BE PERFORMED ACCORDANCE WITH CURRENT NATIONAL ELECTRIC CODES AND ALL LOCAL AND STATE CODES, LAWS, AND ORDINANCES. PROVIDE ALL COMPONENTS AND WIRING AS REQUIRED TO MEET NEC.

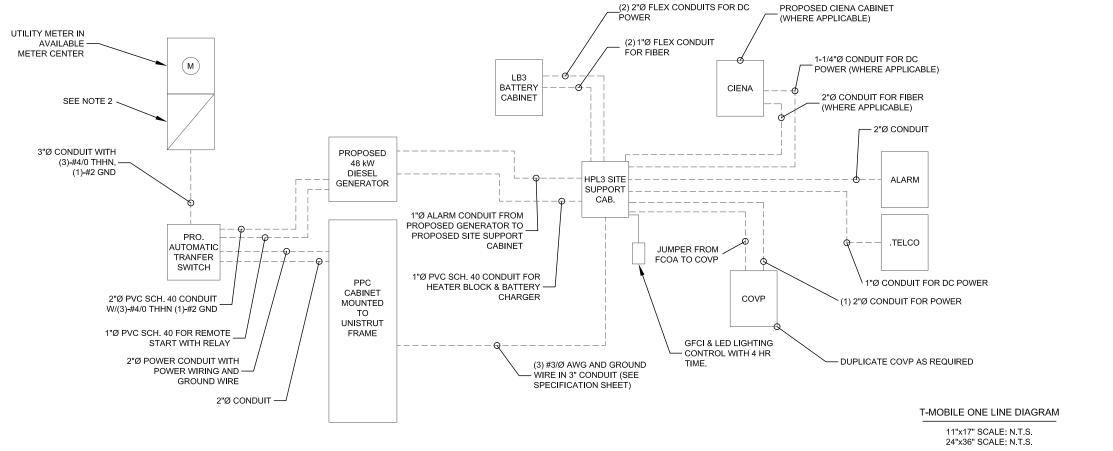

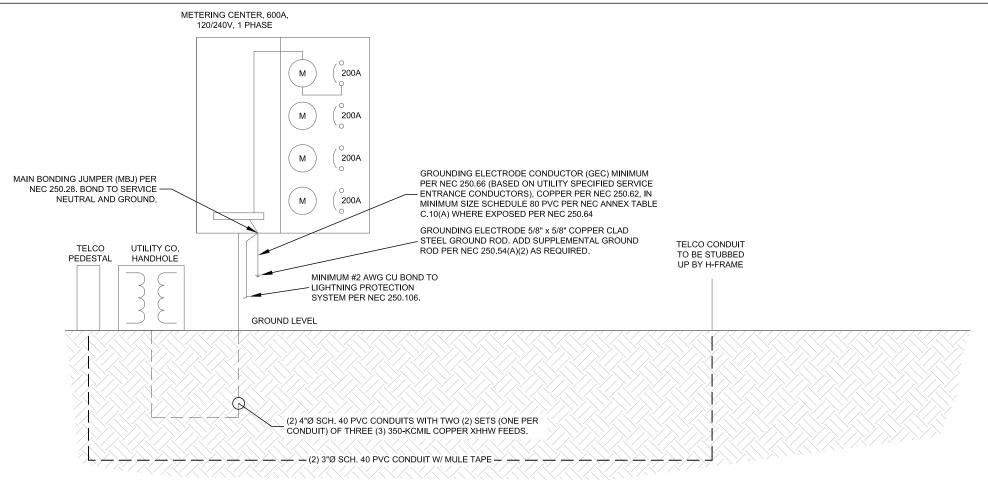

ELECTRICAL SINGLE-LINE DIAGRAM

11"x17" SCALE: N.T.S. 24"x36" SCALE: N.T.S. BTS II, LLC

750 PARK OF COMMERCE DR, SUITE 200 BOCA RATON, FL 33487






TAMPA FL 33634

ENGINEERING INNOVATION

FDH INFRASTRUCTURE SERVICES, LLC
6521 MERIDIEN DRIVE RALEIGH, NC 27616
PHONE: 919-755-1031

THE INFORMATION CONTAINED IN THIS SET OF DOCUMENTS IS PROPRIETARY BY NATURE. REPRODUCTION OR CAUSING TO BE REPRODUCED THE WHOLE OR ANY PART OF THESE DRAWINGS WITHOUT THE PERMISSION OF FDH IS PROHIBITED.

SUBMITTALS					
REV	DATE	DESCRIPTION	BY	СНК	
0	03/17/2023	CONSTRUCTION	ZK	JRI	
				1 -	

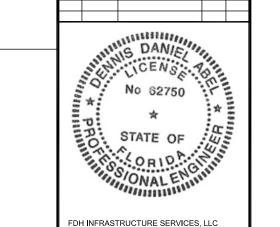

FDH INFRASTRUCTURE SERVICES, LLC DENNIS D. ABEL, PE STATE LICENNSE NO. 62750

FDH JOB NUMBER:

PR-008353

US-FL-7140

SITE NAME:

HUNGRY HOWIE

T-MOBILE SITE ID:

A2B2227A

, (LDLLLI,

252835000000023020

ADDRESS:

3024 SPIRIT LAKE DRIVE WINTER HAVEN, FL 33880

SHEET TITL

SINGLE LINE DIAGRAM

SHEET NUMBER:

E-4


NOTES


- ALL GROUNDING CONDUCTORS IN EARTH #2 SOLID BARE TINNED COPPER (SBTC).
- 2. ALL CONDUCTOR CONNECTION IN EARTH EXOTHERMICALLY WELDED.
- 3. ALL FENCE POST, TOWER LEGS, FRAME, ETC. METALLIC CONDUCTOR BONDS EXOTHERMICALLY WELDED.
- 4. ALL GROUND BAR CONNECTIONS MECHANICALLY BONDED WITH 2-HOLE CONNECTORS LISTED AND SUITABLE FOR THE APPLICATION.
- 5. MINIMUM 2-FT SEPARATION BETWEEN GROUND RINGS AND FOUNDATIONS IN
- 6. EQUIPMENT CABINET, ICE BRIDGE & EQUIPMENT FRAME GROUNDING TO BE PIGTAILED ABOVE GRADE AT LOCATIONS DESIGNATED FOR FUTURE INSTALLATION OF GROUND EQUIPMENT.
- 7. BOND ALL EQUIPMENT, FRAMES, HYBRID/COAX CABLING, ETC. TO MAIN
- 8. ALL GROUND BARS AT GRADE ARE TO BE BONDED TO GROUND RING IN TWO PLACES WITH PARALLEL EXOTHERMIC WELDED PARALLEL CONNECTION AT GROUND RING (TYP.).


CALLOUTS:

- 1) #2 SOLID BARE TINNED COPPER CONDUCTOR 30" BELOW GRADE OR 6" BELOW FROST LINE, WHICH EVER IS GREATER (TYP.) MINIMUM 24" BENDING RADIUS. SEE DETAIL SHEET G-2.
- (2) 5/8"x10' COPPER CLAD GROUND ROD (MIN. 10' APART). SEE DETAIL SHEET G-3.
- 3 BOND ALL CORNER POSTS. SEE DETAIL SHEET G-2.
- (4) 5/8"Ø 10' LONG COPPER CLAD GROUND ROD WITH INSPECTION WELL, TOP OF GROUND ROD MAX 24" BURIED. SEE DETAIL SHEET G-3.
- (5) BOND TOWER TO TOWER GROUND RING WITH 2 CONNECTIONS EACH DIRECTED IN OPPOSITE DIRECTIONS ON GROUND RING. SEE DETAIL SHEET G-2
- (6) #2 SOLID BARE TINNED COPPER LEADS (FROM GATE POST TO COMPOUND GROUNDING). SEE DETAIL SHEET G-2.
- (7) BRAIDED STRAP CONNECTIONS (FROM GATE POST TO GATE).
- (8) PROPOSED CHAIN LINKED FENCE. SEE DETAIL SHEET ###.
- 9 LOWER TOWER GROUND BAR. SEE DETAIL SHEET G-3.
- (10) GROUND PROPOSED METER AND DISCONNECT. SEE SHEET E-4.
- (1) PROVIDE AN EXTERNAL #2 TINNED COATED GROUND LEAD FROM GROUND RING TO ALL METAL CABINETS ON UTILITY BACKBOARD (TELCO, ELECTRIC, BREAKER PANELS, METER RACKS, JUNCTION BOXES, ETC.) SLEEVED IN CONDUIT FROM JUST BELOW GRADE TO SAND CABINETS USING BURNDY TYPE 2 LONG BARREL LUGS WITH NO-OK OR COPPER SHIELD
- BOND THE #2 SOLID BARE TINNED COPPER LEADS FROM H-FRAME & EXOTHERMIC WELD TO COMPOUND GROUND RING

LEGEND #2 SOLID BARE TINNED COPPER CONDUCTOR MECHANICAL CONNECTION (BURNDY OR EQUIVALENT) EXOTHERMIC CONNECTION (CADWELD OR EQUIVALENT) INSPECTION WELL 5/8" DIA. X 10'-0" LONG, STEEL CLAD W/ A PURE COPPER JACKET (10' MIN. SEPARATION)

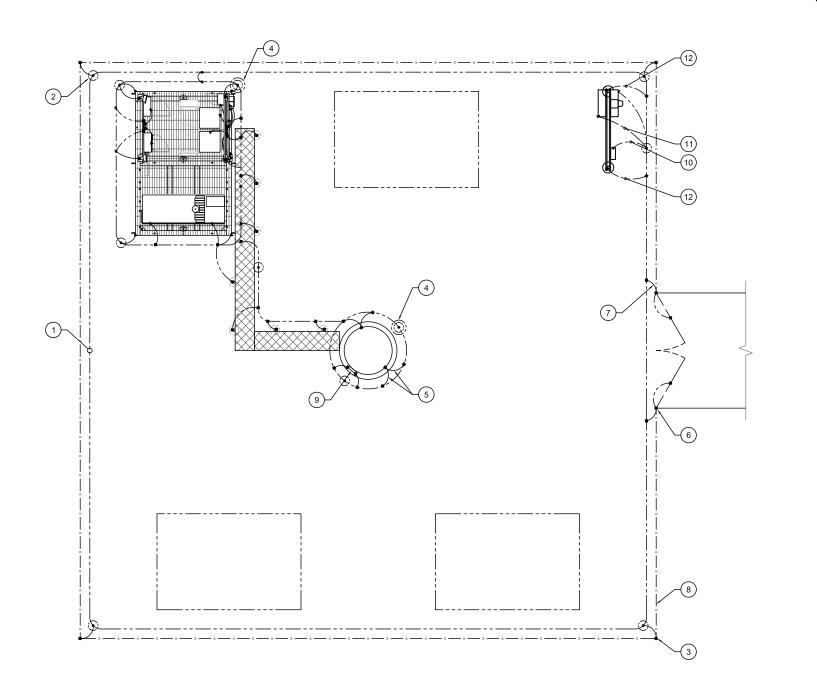

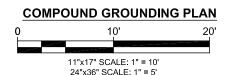

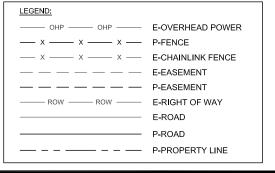

VB II II 2TS

750 PARK OF COMMERCE DR, SUITE 200 BOCA RATON, FL 33487





TAMPA FL 33634

ENGINEERING INNOVATION
FDH INFRASTRUCTURE SERVICES, LLC

THE INFORMATION CONTAINED IN THIS SET OF DOCUMENTS IS PROPRIETARY BY NATURE. REPRODUCTION OR CAUSING TO BE REPRODUCED THE WHOLE OR ANY PART OF THESE DRAWINGS WITHOUT THE PERMISSION OF FDH IS PROHIBITED.

SUBMITTALS					
REV	DATE	DESCRIPTION	BY	CHK'D	
0	03/17/2023	CONSTRUCTION	ZK	JRB	



FDH INFRASTRUCTURE SERVICES, LLC DENNIS D. ABEL, PE STATE LICENNSE NO. 62750

FDH JOB NUMBER:

PR-008353

SITE ID: US-FL-7140

SITE NAME:

HUNGRY HOWIE

T-MOBILE SITE ID:

A2B2227A

252835000000023020

ADDRESS:

3024 SPIRIT LAKE DRIVE WINTER HAVEN, FL 33880

SHEET TITL

COMPOUND GROUNDING PLAN

SHEET NUMBER


G-1

NOTES

- ALL GROUNDING CONDUCTORS IN EARTH #2 SOLID BARE TINNED COPPER (SBTC).
- 2. ALL CONDUCTOR CONNECTION IN EARTH EXOTHERMICALLY WELDED.
- 3. ALL FENCE POST, TOWER LEGS, FRAME, ETC. METALLIC CONDUCTOR BONDS EXOTHERMICALLY WELDED.
- ALL GROUND BAR CONNECTIONS MECHANICALLY BONDED WITH 2-HOLE CONNECTORS LISTED AND SUITABLE FOR THE APPLICATION.
- 5. MINIMUM 2-FT SEPARATION BETWEEN GROUND RINGS AND FOUNDATIONS IN ALL LOCATIONS.
- BOND ALL EQUIPMENT, FRAMES, HYBRID/COAX CABLING, ETC. TO MAIN GROUND BAR.
- 8. ALL GROUND BARS AT GRADE ARE TO BE BONDED TO GROUND RING IN TWO PLACES WITH PARALLEL EXOTHERMIC WELDED PARALLEL CONNECTION AT GROUND RING (TYP.).

CALLOUTS:

- (1) 5/8"x10' COPPER CLAD GROUND ROD (MIN. 10' APART).
- (2) GROUND ROD 5/8"ØX10' LONG WITH INSPECTION WELL (TYP.)
- (3) EXOTHERMIC WELD CONNECTION TO ICE BRIDGE POST (TYP.)
- (4) 2-HOLE LUG MECHANICAL CONNECTION (TYP.)
- (5) #2 TINNED SOLID COPPER EQUIPMENT GROUND RING. (MINIUM 30" BELOW GRADE.)
- (6) PROPOSED T-MOBILE EQUIPMENT (TYP.)
- (7) GPS ANTENNA GROUND
- (2) #2 AWG BARE TINNED GROUND WIRE TO EQUIPMENT GROUND RING. GROUND GENERATOR PER MANUFACTURER'S RECOMMENDATION.
- (9) #2 AWG ICE BRIDGE BOND BURIED 36" BFG (TYP. ALL POSTS)
- 10) GROUND EQUIPMENT GROUND BAR
- (1) #2 TINNED SOLID COPPER GROUND WIRE FROM GROUND RING TO BUSS BAR INSIDE CABINET.

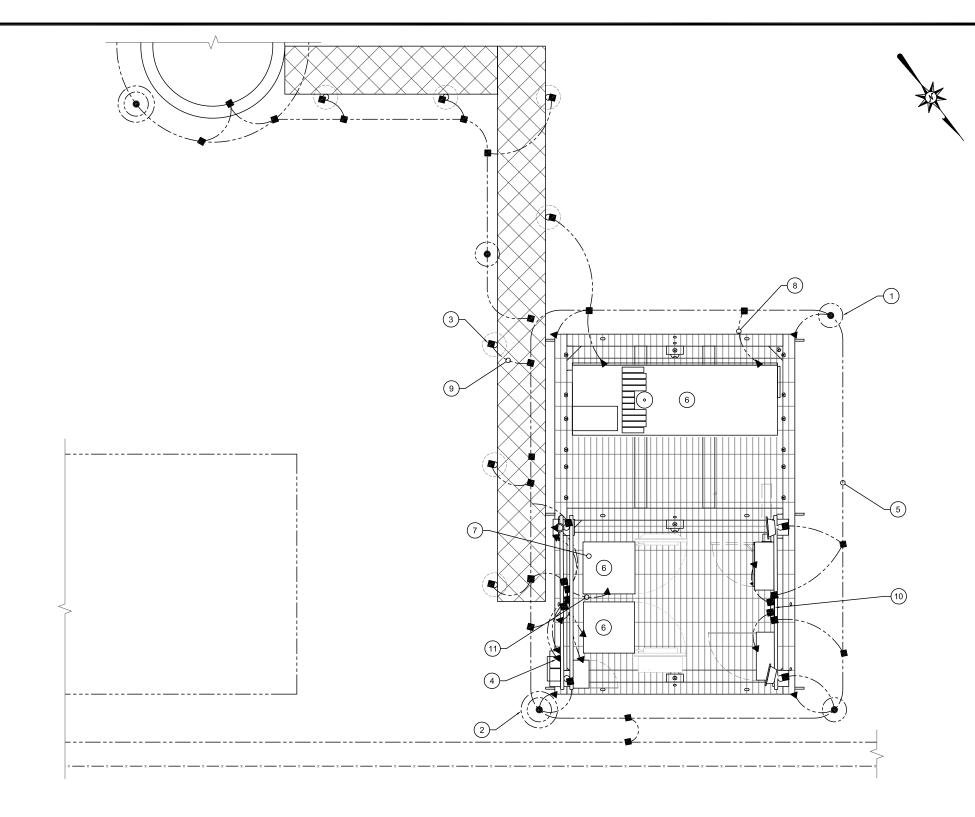


LEGEND

--- #2 SOLID BARE TINNED COPPER CONDUCTOR

- MECHANICAL CONNECTION (BURNDY OR EQUIVALENT)
- EXOTHERMIC CONNECTION (CADWELD OR EQUIVALENT)
- (inspection
- (5/8" DIA. X 10'-0" LONG, STEEL CLAD W/ A PURE COPPER JACKET (10' MIN. SEPARATION)



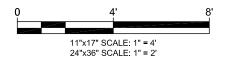

 LEGEND:
 OHP — OHP — E-OVERHEAD POWER

 — X — X — X — P-FENCE

 — X — X — X — E-CHAINLINK FENCE

 — — — — P-EASEMENT

 — ROW — ROW — E-RIGHT OF WAY

 — E-ROAD

 — P-ROAD

 — P-PROPERTY LINE

BTS II, LLC

750 PARK OF COMMERCE DR, SUITE 200 BOCA RATON, FL 33487





TAMPA, FL 33634

ENGINEERING INNOVATION
FDH INFRASTRUCTURE SERVICES, LLC

6521 MERIDIEN DRIVE RALEIGH, NC 27616 PHONE: 919-755-1012 FAX: 919-755-1031

THE INFORMATION CONTAINED IN THIS SET OF DOCUMENTS IS PROPRIETTARY BY NATURE. REPRODUCTION OR CAUSING TO BE REPRODUCED THE WHOLE OR ANY PART OF THESE DRAWINGS WITHOUT THE PERMISSION OF FDH IS PROHIBITED.

SUBMITTALS					
REV	DATE	DESCRIPTION	BY	CHK'D	
0	03/17/2023	CONSTRUCTION	ZK	JRB	



FDH INFRASTRUCTURE SERVICES, LLC DENNIS D. ABEL, PE STATE LICENNSE NO. 62750

FDH JOB NUMBER:

PR-008353

SITE ID: US-FL-7140

SITE NAME:

HUNGRY HOWIE

T-MOBILE SITE ID:

A2B2227A

252835000000023020

ADDRESS:


3024 SPIRIT LAKE DRIVE WINTER HAVEN, FL 33880


SHEET TITLE:

T-MOBILE GROUNDING PLAN


SHEET NUMBER:

G-1.1

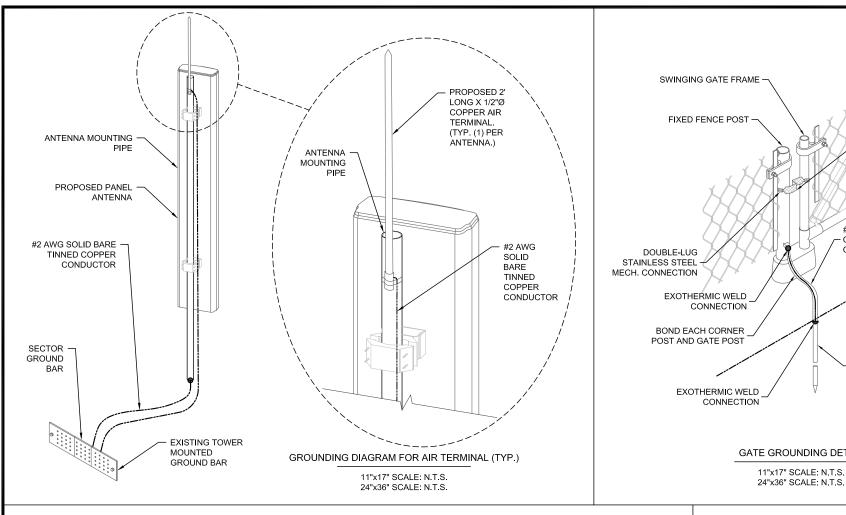

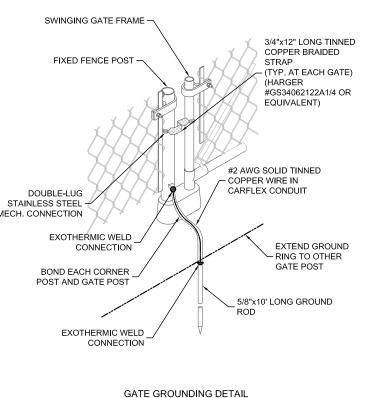

MASTER GROUND BAR AT LIGHTNING ROD TOP OF POLE 4/0 INSULATED STRANDED MASTER GROUND BAR AT #2 SOLID, TINNED, BARE COPPER ROUTED IN BASE OF POLE FLEX CONDUIT UNLESS OTHERWISE NOTED TOWER BASE PLATE NEW GROUND RING (TYP.) NEW MONOPOLE #2 SOLID, TINNED, BARE COPPER PER - MANUFACTURE (TYP.) RECOMMENDATION **TOWER** LIGHT CONTROLLER **NEW PERIMETER GROUND RING** ELECTRICAL FENCE SERVICE GATE GATE FRAME **ENTRANCE** POST GROUND TELCO TRANSIENT UTILITY LOAD COMMON VOLTAGE H-FRAME CENTER BOX SURGE POST SUPPRESSER SINGLE LINE GROUNDING DIAGRAM 11"x17" SCALE: N.T.S. 24"x36" SCALE: N.T.S.

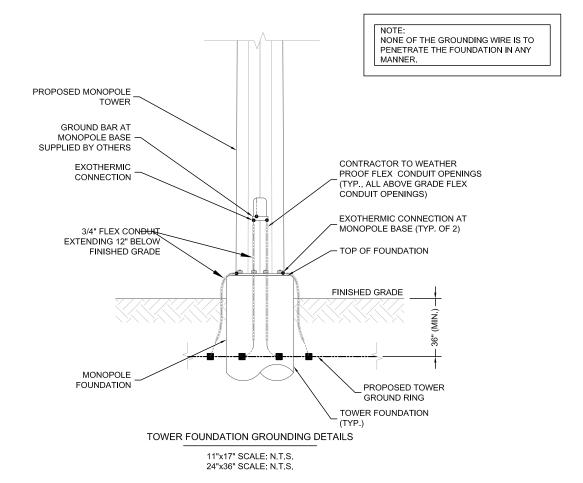

BTS II, LLC

750 PARK OF COMMERCE DR, SUITE 200 BOCA RATON, FL 33487



TAMPA, FL 33634




FDH INFRASTRUCTURE SERVICES, LLC 6521 MERIDIEN DRIVE RALEIGH, NC 27616 PHONE: 919-755-1012 FAX: 919-755-1031

THE INFORMATION CONTAINED IN THIS SET OF DOCUMENTS IS PROPRIETARY BY NATURE.
REPRODUCTION OR CAUSING TO BE REPRODUCED
THE WHOLE OR ANY PART OF THESE DRAWINGS
WITHOUT THE PERMISSION OF FDH IS PROHIBITED.

SUBMITTALS

CODINITITALO					
REV	DATE	DESCRIPTION	BY	CHK'D	
0	03/17/2023	CONSTRUCTION	ZK	JRB	

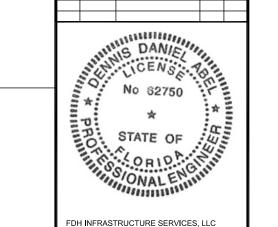

FDH INFRASTRUCTURE SERVICES, LLC DENNIS D. ABEL, PE STATE LICENNSE NO. 62750

FDH JOB NUMBER:

PR-008353

SITE ID: US-FL-7140

SITE NAME:

HUNGRY HOWIE

T-MOBILE SITE ID: A2B2227A

252835000000023020

ADDRESS:


3024 SPIRIT LAKE DRIVE WINTER HAVEN, FL 33880

SHEET TITLE:


GROUNDING DETAILS

SHEET NUMBER:

G-2

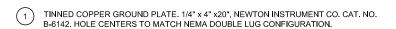


- 5/8" LOCKWASHERS, NEWTON INSTRUMENT CO. CAT NO. 3015-8.
- (3) WALL MOUNTING BRACKET, NEWTON INSTRUMENT CO. CAT NO. A-6056.
- (4) 5/8"-11 x1" H.H.C.S. BOLTS, NEWTON INSTRUMENT CO. CAT NO. 3012-1
- INSULATOR, NEWTON INSTRUMENT CO. (CAT.# 3061-4)

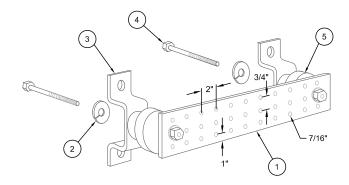

SHELTER GROUND BAR DETAIL

11"x17" SCALE: N.T.S. 24"x36" SCALE: N.T.S.

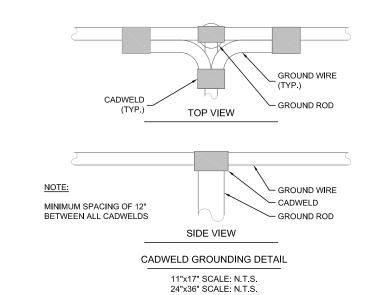

— 30° _{МАХ.} . FINISHED GRADE CADWELD CONNECTION EXOTHERMIC WELD #2 AWG BARE TINNED 5/8"Ø x 10' LONG SOLID COPPER WIRE — GROUND RING GROUND ROD **GROUND ROD DETAIL**

11"x17" SCALE: N.T.S.

24"x36" SCALE: N.T.S.

11"x17" SCALE: N.T.S.

24"x36" SCALE: N.T.S.

PULL TOP COVER

(NATURAL EARTH COVER)

MINIMUM ONE TEST WELL SHALL BE PROVIDED BETWEEN THE TOWER GROUND

CRUSH GRAVEL

EXOTHERMIC WELD CONNECTION FOR GROUNDING CONDUCTORS BETWEEN PROPOSED AND EXISTING SECTIONS OF FENCE.


GENERATOR SYSTEM SHALL BE SOLIDLY GROUNDED PER NEC 250.20.

LEGEND:


MECHANICAL CONNECTION

LOOP AND THE EQUIPMENT GROUND LOOP. EXOTHERMIC CONNECTION

CRUSHED GRAVEL

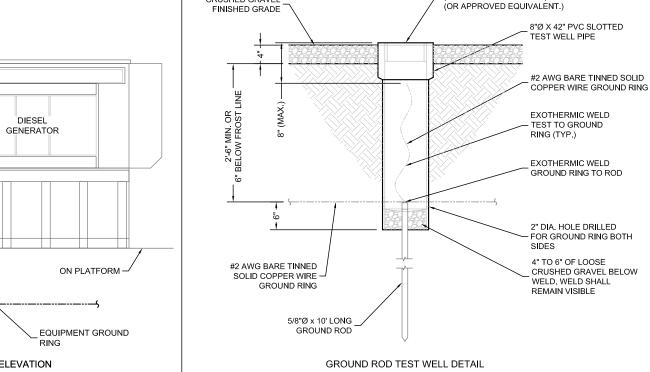

NOTES:

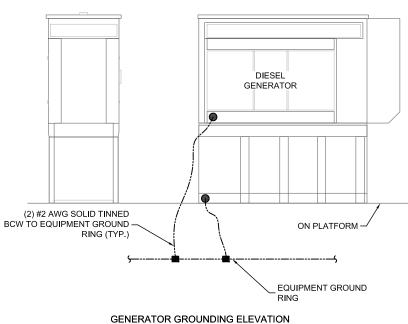

11"x17" SCALE: N.T.S.

24"x36" SCALE: N.T.S.

BTS II, LLC

750 PARK OF COMMERCE DR, SUITE 200 BOCA RATON, FL 33487






TAMPA, FL 33634

ENGINEERING INNOVATION FDH INFRASTRUCTURE SERVICES, LLC 6521 MERIDIEN DRIVE RALEIGH, NC 27616 PHONE: 919-755-1012 FAX: 919-755-1031

THE INFORMATION CONTAINED IN THIS SET OF DOCUMENTS IS PROPRIETARY BY NATURE.
REPRODUCTION OR CAUSING TO BE REPRODUCED
THE WHOLE OR ANY PART OF THESE DRAWINGS
WITHOUT THE PERMISSION OF FDH IS PROHIBITED.

	SUBMITTALS						
REV	DATE	DESCRIPTION	BY	CHK'			
0	03/17/2023	CONSTRUCTION	ZK	JRB			

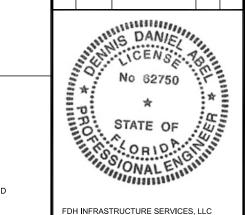

FDH INFRASTRUCTURE SERVICES, LLC DENNIS D. ABEL, PE STATE LICENNSE NO. 62750

FDH JOB NUMBER:

PR-008353

SITE ID: US-FL-7140

SITE NAME:

HUNGRY HOWIE

T-MOBILE SITE ID: A2B2227A

252835000000023020

ADDRESS:


3024 SPIRIT LAKE DRIVE WINTER HAVEN, FL 33880

SHEET TITLE:

GROUNDING DETAILS

SHEET NUMBER:

G-3

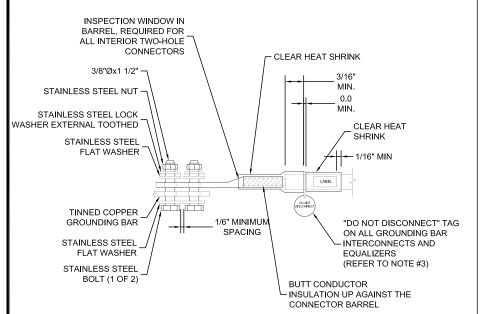

- ALL HARDWARE 18-8 STAINLESS STEEL INCLUDING SPLIT WASHER. COAT ALL SURFACES WITH KIPR-SHIELD BEFORE MATING.
- FOR GROUND BOND TO STEEL ONLY: INSERT A DRAGON TOOTH WASHER BETWEEN LUG AND STEEL, COAT ALL SURFACES WITH KOPR-SHIELD.
- PROVIDE "DO NOT DISCONNECT" TAG AS REQUIRED.

INTERIOR & EXTERIOR TWO HOLE GROUND LUG DETAIL

11"x17" SCALE: N.T.S. 24"x36" SCALE: N.T.S.

SECTIONALY SECTIONALY NIETER BLANK

ELECTRICAL-GROUNDING ROD SYSTEM NOTES:

- 1. ALL GROUNDING CONNECTIONS SHALL BE MADE BY THE EXOTHERMIC PROCESS CONNECTIONS SHALL INCLUDE ALL CABLE TO CABLE, SPLICES, ETC. ALL CABLE TO GROUND RODS, GROUND RODS SPLICES, AND LIGHTNING PROTECTION SYSTEM AS INDICATED. ALL MATERIALS USED (MOLDS, WELDING, METAL, TOOLS, ETC.) SHALL BE BY EXOTHERMIC PROCESS AND INSTALLED PER MANUFACTURERS RECOMMENDATIONS AND PROCEDURES. GROUND CONDUCTOR SHALL HAVE A MINIMUM 24" BENDING RADIUS.
- 2. ALL EXOTHERMIC CONNECTIONS ON GALVANIZED SURFACES SHALL BE CLEANED THOROUGHLY AND COLORED TO MATCH SURFACE WITH (2) TWO COATS OF SHERWIN-WILLIAMS GALVITE (WHITE) PAINT B50W3 (OR EQUAL) OR SHERWIN-WILLIAMS SILVERBRITE (ALUMINUM) B59S11 (OR EQUAL).
- ALL ELECTRICAL & MECHANICAL GROUND CONNECTIONS SHALL HAVE A CONDUCTIVE RUST AND CORROSION INHIBITOR (T&B KOPR-SHIELD OR EQUIVALENT) APPLIED TO CONNECTION.
- 4. INSTALL ALL GROUND RODS VERTICALLY IN UNDISTURBED EARTH.
 WHERE SOLID ROCK IS ENCOUNTERED, INSTALL MAX 45° ANGLE AWAY
 FROM EQUIPMENT, TOWER, OR OTHER ABOVE GROUND ELEMENTS BEING
 PROTECTED.
- 5. GROUND RING AROUND BUILDING SHALL BE #2 SOLID TINNED BARE COPPER (SBTC), BARE TINNED COPPER CONDUCTOR, IN CONTACT WITH BARE EARTH AT A MINIMUM DEPTH OF 36". ALL CONDUCTOR BENDS SHALL NOT BE LESS THAN A MINIMUM RADIUS OF 24".
- 6. THE FENCE AND GATE POSTS SHALL BE BONDED TO THE GROUNDING SYSTEM WITH #2 SBTC EXOTHERMICALLY WELDED TO THE POST. BOND SWING GATE TO GATE POST WITH #4/0 FLEXIBLE COPPER STRANDED CONDUCTOR (WELDING CONDUCTOR OR SIMILAR). ALL CONNECTIONS SHALL BE EXOTHERMICALLY WELDED WITH COLD-GALVANIZED PAINT APPLIED AFTER WELDING.
- BOND ALL CONDUCTIVE ELEMENTS TO GROUNDING SYSTEM THAT ARE WITHIN 5-FT OF ANY PART OF GROUNDING SYSTEM OR WITHIN 20-FT OF TOWER RING USING SIMILAR SYSTEMS AS APPLIED TO FENCE CORNER POSTS.
- ALL DETAILS ARE SHOWN IN GENERAL TERMS. ACTUAL GROUNDING
 INSTALLATION AND CONSTRUCTION MAY VARY DUE TO THE SPECIFIC SITE
 CONDITIONS.

- 9. UTILITY COMPANY COORDINATION: ELECTRICAL CONTRACTOR SHALL CONFIRM THAT ALL WORK IS IN ACCORDANCE WITH THE RULES OF THE LOCAL UTILITY COMPANY BEFORE SUBMITTING THE BID, THE CONTRACTOR SHALL CHECK WITH THE UTILITY COMPANIES SUPPLYING SERVICE TO THIS PROJECT AND SHALL DETERMINE FROM THEM ALL EQUIPMENT AND CHARGES WHICH THEY WILL REQUIRE AND SHALL INCLUDE THE COSTS IN THE BID.
- 10. THIS GROUNDING SYSTEM HAS BEEN DESIGNED TO ACHIEVE A RESISTANCE MEASUREMENT PERFORMANCE OF 5 OHMS OR LESS. SHOULD THE RESULT NOT ACHIEVE THIS DESIRED PERFORMANCE, CONTACT ENGINEER FOR FURTHER ACTION.
- 11. GROUND RINGS ARE TO BE INSTALLED A MINIMUM OF 2'-0" FROM EQUIPMENT AND TOWER.

ELECTRICAL-GROUNDING ROD SYSTEM NOTES:

- 1. GROUND RODS SHALL BE INSTALLED NO CLOSER THAN 10-FT APART.
- GROUND RODS SHALL BE INSTALLED WITH TOPS AT THE SAME DEPTH AS GROUNDING SYSTEM CONDUCTOR (RING OR RADIAL).
- 3. ALL BELOW GRADE GROUND RINGS AND GROUND LEADS SHALL BE #2 AWG SOLID, TINNED BARE COPPER WIRE.
- 4. ALL BELOW GROUND CONNECTIONS SHALL BE EXOTHERMIC WELDS.
- UNLESS PROVIDED WITH A FACTORY APPLIED LEAD, ALL CONNECTIONS TO GROUND BARS SHALL BE BURNDY HYGROUND COMPRESSION LUGS OR EQUAL.
- STEEL SHALL BE TO BARE METAL. GRIND GALV. FINISH OR PAINT OFF PRIOR TO WELDING, REPAIR GALV. FINISH OR PAINT AS REQUIRED, MATCH PAINT COLOR.
- 7. ALL LUG CONNECTORS SHALL BE 2 HOLE LONG BARREL COMPRESSION
 TYPE OR APPROVED FOLIAL
- 8. ALL HARDWARE TO ATTACH MECHANICAL GROUND CONNECTIONS SHALL BE STAINLESS STEEL.
- 9. ALL MECHANICAL CONNECTIONS SHALL HAVE CONDUCTIVE ANTI-OXIDANT COMPOUND APPLIED BETWEEN COMPRESSION LUG AND FIXTURE.

#2 SBTC NFPA 780 (2) #2 SBTC (2) #2 SBTC NSTD33-11 NSTD33-11 #2/0 I-STR #6 I-STR

#6 I-STR

#6 I-STR #6 I-STR NSTD33-14.5

#6 I-STR #750MCM I-STR

#2/0 I-STR #6 I-STR

#6 I-STR #2/0 I-STR

NSTD33-11 NSTD33-11

#2 I-STR

#6 I-STR BY FASTENERS #2/0 I-STR

#6 I-STR #8 I-STR

NSTD33-22

#6 I-STR

#6 I-STR #6 I-STR

#2/0 I-STR #2 I-STR #6 I-STR

#2 SBTC

LEAD IDENTIFICATION & DESCRIPTION:

1 1A 2 3 4	RING, EXTERNAL BURIED W/RODS RING, CONCRETE ENCASED DEEP ANODE (TO IMPROVE OHMS) RING TO BLDG STL FRAME MAN AC PANEL NEUTRAL BUS TO (2)	#2 SBTC #2 SBTC ROD OR PIPE #2 SBTC	25 26 27 28 29	RING TO NEAREST LIGHTNING ROD LIGHTNING ROD SYS TO NEARBY MTL RING TO TOWER RING RING TO SHELTER RING BRANCH AC PNL TO BTTY CHG FRM
5 6 7 8	GROUND RODS, ISOLATED FROM LEAD #1 RING TO GROUND BAR RING TO EXT MTL OBJECT DEEP ANODE TO MGB AC PANEL TO WATER METER	NEC 250.66 (2) #2 SBTC #2 SBTC NSTD33-9 NEC 250.66	30 31 32 33 34	BRANCH AC PNL TO OUTLETS MGB/FGB TO PWR, BTTY FRAMES #31 TO BATTERY CHARGER FRAME #31 TO BATTERY RACK FRAME #31 TO PCU FRAME
9 10 11-12 13 14	EXT WATER TO INT WATER PIPES INT WATER PIPE TO MGB NOT USED AC PANEL TO MGB MGB/FGB TO BLDG STL FRAME	NSTD33-9 NSTD33-9 NSTD33-9 #2/0 I-STR	35 36 37 37A 38	#31 TO DCU FRAME #31 TO PCU FRAME MGB/FGB TO BTTY RETURN MGB/FGB TO RTN TERM CARR SUPP FGB TO PDU GB
14C 15 16 16A 17	MGB/FGB TO ROOF/WALL MTL PNL MGB/FGB TO FGB-HE SAME FLOOR NOT USED ECPGB TO CABLE ENTRY RACK MGB TO CABLE SHIELDING	#1/0 I-STR #2/0 I-STR #1/0 I-STR #6 I-STR	38A 39 40 41A 42-44	FGB TO PDU GB CARRIER SUPPLY DC BUS DUCT TO NEXT SECTION DC BUS DUCT TO MGB/FGB MGB/FGB TO #58 NOT USED
17A 17B 18 19 20	ECPGB TO CABLE SHIELDING MGB/FGB TO F-0 SPLICE SHELF LOWEST MGB/FGB TO HIGHEST FGB LEAD 18 TO OTHER FGB, <6' MGB/FGB TO BRANCH AC PNL	#6 I-STR #1 I-STR #2/0 I-STR #2/0 I-STR #6 I-STR	45 46 47 48 49	MAIN AC PNL TO BRANCH AC PNL BRANCH AC PNL TO DED OUTLET FGB TO INTEG FRM LEAD #31 TO INTEG FRM INTEG FRM TO EQUIP SHELF
20A 20B 21 21A 21B	NEAREST GRIND TO DISCONNECT PNL GWB TO AC DISTR PNL MGB/FGB TO INT HALO INTERIOR 'GREEN' HALO INT HALO TO EXT RING	NEC 250.66 #6 I-STR #2 I-STR #2 I-STR #2 SBTC	50 51 52 53A 54	PDU BTTY RET TO #51 #50 TO TRANS FROM ISO DC PWR TRANS FRM FUSE TO FRM OR BAR MGB/FGB TO PDF/BDFB MGB/FGB TO STATIC DEVICES
21C 22 23 23A 24 24A	INT HALO TO EQUIPMENT MTL ROOF TOWER RING TO ROOF GRND MGB/FGB TO ECPGB, SAME FLOOR MGB/FGB TO CXR-HF LINR PROT ECPGB TO EACH PROTECTOR ASSEMBLY LOWER PROT ASSY TO UPPER	#6 I-STR NFPA 780 #1 I-STR #6 I-STR #6 I-STR #6 I-STR	55 56 57A 58A 59A 60-89	MGB/FGB TO CABLE AT ENTRY MGB/FGB TO AC PWR RADIO XMTTR MGB/FGB TO CBLGRID/RUNWAY #41A TO AISLE FRAME #58A TO EACH SGL FRAME GRND NOT USED GENERATOR FRAME TO EXT RING



750 PARK OF COMMERCE DR, SUITE 200 BOCA RATON, FL 33487



SUITE 110 A-B

TAMPA FL 33634




ENGINEERING INNOVATION

FDH INFRASTRUCTURE SERVICES, LLC

6821 MERIDIEN DRIVE RALEIGH, NC 27616
PHONE 1918-755-1021 FAX: 919-755-1021

THE INFORMATION CONTAINED IN THIS SET OF DOCUMENTS IS PROPRIETARY BY NATURE. REPRODUCTION OR CAUSING TO BE REPRODUCED THE WHOLE OR ANY PART OF THESE DRAWINGS WITHOUT THE PERMISSION OF FOH IS PROHIBITED.

		SUBMITTALS		
REV	DATE	DESCRIPTION	BY	СНК
0	03/17/2023	CONSTRUCTION	ZK	JRI

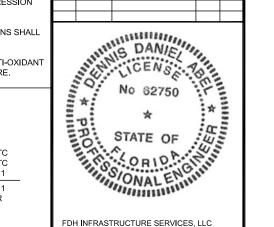

FDH INFRASTRUCTURE SERVICES, LLC DENNIS D. ABEL, PE STATE LICENNSE NO. 62750

FDH JOB NUMBER:

PR-008353

US-FL-7140

SITE NAME:

HUNGRY HOWIE

T-MOBILE SITE ID:

A2B2227A

DADCEI.

252835000000023020

ADDRESS:

3024 SPIRIT LAKE DRIVE WINTER HAVEN, FL 33880

SHEET TITLE:

GROUNDING NOTES

SHEET NUMBER:

G-4

GENERAL NOTES:

- ALL WORK SHALL BE DONE IN ACCORDANCE WITH ALL APPLICABLE FEDERAL, STATE AND LOCAL CODES AND ORDINANCES, IT IS THE CONTRACTOR'S RESPONSIBILITY TO OBTAIN ALL PERMITS NECESSARY TO COMPLETE THE PROJECT AND ABIDE BY ALL CONDITIONS AND REQUIREMENTS OF THE PERMITS.
- THE CONTRACTOR SHALL BE RESPONSIBLE FOR VERIFICATION OF ALL DIMENSIONS, ELEVATIONS AND EXISTING CONDITIONS AT THE SITE BEFORE ORDERING ANY MATERIALS OR DOING ANY WORK. NO EXTRA CHARGE OR COMPENSATION SHALL BE ALLOWED DUE TO DIFFERENCE BETWEEN ACTUAL DIMENSIONS AND DIMENSIONS INDICATED ON THE CONSTRUCTION DRAWINGS. ANY SUCH DISCREPANCY IN DIMENSION WHICH MAY BE FOUND SHALL BE SUBMITTED TO FDH FOR CONSIDERATION BEFORE THE CONTRACTOR PROCEEDS WITH THE WORK IN THE AFFECTED AREAS.
- INCORRECTLY FABRICATED, DAMAGED, OTHERWISE MISFITTING, OR NON-CONFORMING MATERIALS AND CONDITIONS SHALL BE REPORTED TO FDH PRIOR TO ANY REMEDIAL OR CORRECTIVE ACTION. ALL ACTIONS SHALL REQUIRE FDH APPROVAL.
- IT IS THE CONTRACTOR'S SOLE RESPONSIBILITY TO DETERMINE ERECTION PROCEDURE AND SEQUENCE TO ENSURE THE SAFETY OF THE STRUCTURE AND ITS COMPONENT PARTS DURING ERECTION AND/OR FIELD MODIFICATIONS, THIS INCLUDES, BUT IS NOT LIMITED. TO THE ADDITION OF TEMPORARY BRACING, GUYS OR TIE DOWNS THAT MAY BE NECESSARY. SUCH MATERIAL SHALL BE REMOVED AFTER THE COMPLETION OF THE PROJECT
- CONTRACTOR SHALL PROMPTLY REMOVE ANY & ALL DEBRIS FROM SITE AND RESTORE AS BEST AS POSSIBLE TO PRECONSTRUCTION CONDITION
- ALL CONSTRUCTION MEANS AND METHODS; INCLUDING BUT NOT LIMITED TO, ERECTION PLANS, RIGGING PLANS, CLIMBING PLANS, AND RESCUE PLANS SHALL BE THE RESPONSIBILITY OF THE GENERAL CONTRACTOR RESPONSIBLE FOR THE EXECUTION OF THE WORK CONTAINED HEREIN AND SHALL MEET FEDERAL, STATE, AND LOCAL REGULATIONS: AND ANY APPLICABLE INDUSTRY CONSENSUS. STANDARDS RELATED TO THE CONSTRUCTION ACTIVITIES BEING PERFORMED.

SUBSTITUTES AND/OR EQUALS:

IF CONTRACTOR WISHES TO FURNISH OR USE A SUBSTITUTE ITEM OF MATERIAL OR EQUIPMENT, CONTRACTOR SHALL FIRST MAKE WRITTEN APPLICATION TO ENGINEER OF RECORD FOR ACCEPTANCE THEREOF, CERTIFYING THAT THE PROPOSED SUBSTITUTE WILL PERFORM ADEQUATELY THE FUNCTIONS AND ACHIEVE THE RESULTS CALLED FOR BY THE GENERAL DESIGN, BE SIMILAR IN SUBSTANCE TO THAT SPECIFIED AND SUITED TO THE SAME USE AS THAT SPECIFIED. ALL VARIATIONS OF THE PROPOSED SUBSTITUTE FROM THAT SPECIFIED WILL BE IDENTIFIED IN THE APPLICATION AND AVAILABLE MAINTENANCE, REPAIR AND REPLACEMENT SERVICE WILL BE INDICATED. THE APPLICATION WILL ALSO CONTAIN AN ITEMIZED ESTIMATE OF ALL COSTS OR CREDITS THAT WILL RESULT DIRECTLY OR INDIRECTLY FROM ACCEPTANCE OF SUCH SUBSTITUTE INCLUDING COSTS OF REDESIGN AND CLAIMS OF OTHER CONTRACTORS AFFECTED BY THE RESULTING CHANGE, ALL OF WHICH WILL BE CONSIDERED BY ENGINEER OF RECORD IN EVALUATION OF THE PROPOSED SUBSTITUTE. ENGINEER OF RECORD MAY REQUIRE CONTRACTOR TO FURNISH ADDITIONAL DATA ABOUT THE PROPOSED

CONTRACTOR NOTES:

- GENERAL CONTRACTOR MUST BE FAMILIARIZED WITH THE STRUCTURAL PLANS AND HOW THEY INTERACT WITH OTHER SPECIALTIES PLANS (ARCHITECTURAL, M.E.P., ETC), ALTHOUGH TRADE COORDINATION HAS BEEN PERFORMED, FDH SHALL BE CONTACTED IMMEDIATELY IN CASE THE CONTRACTOR FINDS ANY MISSING, AMBIGUOUS, UNCLEAR OR CONFLICTING INFORMATION.
- CONTRACTOR IS RESPONSIBLE FOR ALL CONSTRUCTION MEANS AND METHODS. SHOULD THE CONTRACTOR REQUIRE DIRECT CONSULTATION, FDH IS WILLING TO OFFER SERVICES BASED UPON AN AGREED FEE FOR THE WORK REQUIRED
- THE CONTRACTOR SHALL ALWAYS KEEP ON SITE THE LATEST REVISION OF THE SIGNED AND SEALED STRUCTURAL PLANS, APPROVED SHOP DRAWINGS AND PRODUCT APPROVALS.
- GENERAL CONTRACTOR IS SOLELY RESPONSIBLE FOR ALL ACTIVITIES RELATED TO WORK SAFETY
- CONSTRUCTION LOADS SHOULD BE CAREFULLY DISTRIBUTED TO AVOID LOADING ANY MEMBERS IN EXCESS OF THEIR CAPACITY
- THE APPROVAL BY THE STRUCTURAL INSPECTOR OF ANY WORK DOES NOT RELIEVE THE CONTRACTOR FROM COMPLYING WITH THE FLORIDA BUILDING CODE AND THE APPROVED STRUCTURAL PLANS
- NEITHER THE PROFESSIONAL ACTIVITIES OF FDH NOR THE PRESENCE OF FDH OR EMPLOYEES AND SUB-CONSULTANTS AT THE CONSTRUCTION SITE, SHALL RELIEVE THE GENERAL CONTRACTOR AND OR SUBCONTRACTORS AND ANY OTHER ENTITY OF THEIR OBLIGATIONS, DUTIES AND RESPONSIBILITIES INCLUDING BUT NOT LIMITED TO CONSTRUCTION MEANS METHODS SEQUENCE TECHNIQUES OR PROCEDURES NECESSARY FOR PERFORMING, SUPERINTENDING OF COORDINATING ALL PORTIONS OF THE WORK OF CONSTRUCTION IN ACCORDANCE WITH THE CONTRACT DOCUMENTS AND ANY HEALTH OR SAFETY PRECAUTIONS REQUIRED BY ANY REGULATORY AGENCIES. THE GENERAL CONTRACTOR AND OR SUBCONTRACTOR IS SOLELY RESPONSIBLE FOR JOB SAFETY, AND WARRANTS THAT THIS INTENT IS EVIDENT BY ACCEPTING THIS WORK
- ALL SUBMITTAL INFORMATION MUST BE SENT TO FDH 6521 MERIDIEN DRIVE, RALEIGH, NC 27616, TEL. (919) 755-1012, FAX. (919) 755-1031, E-MAIL STRUCTURAL@FDH-IS.COM. ANY VARIATION OF THESE SPECIFICATIONS OR DRAWINGS WITHOUT CONSENT FROM FDH WILL VOID ANY RESPONSIBILITY OR LIABILITY FOR DAMAGE (MATERIAL OR PHYSICAL) TOWARDS FDH.

COLD GALVANIZATION/SURFACE PREPARATION NOTES:

- CONTRACTOR TO USE ZINGA OR ZRC COLD GALVANIZATION COMPOUNDS OR APPROVED EQUIVALENT.
- PREPARE RUSTED/CORRODED SURFACE FOR TREATMENT ACCORDING TO MANUFACTURER'S RECOMMENDATIONS.
- CONTRACTOR TO APPLY (2) COATS OF COLD GALVANIZATION COMPOUND PER MANUFACTURER'S RECOMMENDATION. DRYING AND CURING TIMES MUST BE UTILIZED PER MANUFACTURER'S
- APPLY ALL COATINGS BY BRUSH IN CALM WIND CONDITIONS. THE USE OF AEROSOL IS NOT PERMITTED.
- IF THE STRUCTURE IS PAINTED, BRUSH PAINT ALL TREATED AREAS TO MATCH STRUCTURE AFTER COLD GALVANIZATION COMPOUND IS ALLOWED TO CURE

STEEL:

- ALL STRUCTURAL STEEL SHALL BE FABRICATED AND ERECTED IN ACCORDANCE WITH THE LATEST AISC CODES AND ASTM SPECIFICATIONS.
- HOT-ROLLED STRUCTURAL SHAPES = ASTM A992.
- PIPES = ASTM A53 GRADE B
- RECTANGULAR HSS = ASTM 500 GRADE B-46
- PLATES = ASTM A36
- ANGLES = ASTM A36 BOLTS = ASTM A325.
- NUTS = ASTM A194. WASHERS = ASTM F436.
- ANCHOR RODS = ASTM F1554 GRADE 105.
- ELECTRODES = E-70XX
- 3. ALL CONNECTIONS OF STRUCTURAL STEEL MEMBERS SHALL BE MADE USING SPECIFIED WELDS WITH WELDING ELECTRODES NOTED IN THE MATERIALS LIST ABOVE OR SPECIFIED HIGH STRENGTH BOLTS TO BE ASTM A325N, THREAD INCLUDED WITH SHEAR PLANE (UNLESS NOTED
- ALL BOLTED CONNECTIONS TO BE INSTALLED TO A SNUG-TIGHTENED CONDITION IN ACCORDANCE WITH AISC 13 PART 16.2. "SPECIFICATION FOR STRUCTURAL JOINTS USING ASTM A325 OR A490 BOLTS" SECTION 8.1. UNI ESS OTHERWISE SPECIFIED. WHEN "X" TYPE BOLTS ARE USED, CONTRACTOR MAY BE REQUIRED TO STACK ADDITIONAL WASHERS TO OBTAIN PROPER SNUG TIGHT INSTALLATION. ALL NUTS SHALL BE HEAVY HEX UNLESS NOTED OTHERWISE.
- 5. ALL STEEL, AFTER FABRICATION, SHALL BE HOT DIPPED GALVANIZED PER ASTM A-123 LINI ESS NOTED OTHERWISE, ALL DAMAGED SURFACES, WELDED AREAS AND AUTHORIZED NON-GALVANIZED MEMBERS OR PARTS (EXISTING OR NEW) SHALL BE PAINTED WITH MULTIPLE COATS OF ZRC COLD GALVANIZING COMPOUND ACHEIVING A MINIMUM OF 4 MILS DRY FILM PER ASTM A 780
- 6. A490 OR 354-GR. BD BOLTS SHALL NOT BE HOT DIPPED GALVANIZED, MECHANICALLY OR ELECTROPLATED
- 7. ALL A490 OR 354-GR. BD BOLTS SHALL BE COATED WITH A ZINC/ALUMINUM COATING (MAGNI 565 OR APPROVED EQUAL) PER ASTM F2833, BY THE BOLT MANUFACTURER
- 8. CONTRACTOR TO PROVIDE FULL DOCUMENTATION ON A490 OR 354-GR. BOLTS PRIOR TO INSTALLATION.
- 9. ALL SHOP AND FIELD WELDING SHALL BE DONE BY WELDERS QUALIFIED AS DESCRIBED IN THE "AMERICAN WELDING SOCIETY'S STANDARD QUALIFICATION PROCEDURE" TO PERFORM THE TYPE OF WORK REQUIRED. CONTRACTOR IS REQUIRED TO PROVIDE FDH WITH A PASSING CERTIFIED WELDING INSPECTION FOR ALL WELDS.
- 10 STRUCTURAL STEEL MAY NOT BE TORCH CUT FOR FABRICATION ALL STEEL FARRICATION MUST FOLLOW AISC STANDARDS.

PROJECT CODES USED:

- ALL STRUCTURAL ELEMENTS FOR THIS PROJECT HAVE BEEN DESIGNED PER 2018 INTERNATIONAL BUILDING CODE, 6TH EDITION. 2017. THIS IMPLIES THE USE OF THE BELOW LISTED CODES.
 - ASCE 7-16, MINIMUM DESIGN LOADS FOR BUILDINGS AND OTHER
 - ASCE 24-14, FLOOD RESISTANT DESIGN AND CONSTRUCTION.
 - AISC 360-16. SPECIFICATION FOR STRUCTURAL STEEL BUILDINGS AISC 303-16, CODE OF STANDARD PRACTICE FOR STEEL
 - BUILDINGS AND BRIDGES AISC 348-14 / 2014 RCSC, SPECIFICATION FOR STRUCTURAL JOINTS USING HIGH STRENGTH BOLTS.
 - FEMA P-55, COASTAL CONSTRUCTION MANUAL

FABRICATION NOTES:

- ALL DIMENSIONS ARE PRELIMINARY UNTIL FIELD VERIFIED BY CONTRACTOR. ANY CHANGES MUST BE APPROVED BY ENGINEER OF RECORD IN WRITING PRIOR TO FABRICATION AND INSTALLATION.
- 2. NEW STEEL MEMBERS MUST HAVE SINGLE DRILLED HOLES. SLOTTED AND DOUBLE DRILLED HOLES ARE NOT ACCEPTABLE MEANS OF

SURFACE PREPARATION:

- 1. PREPARE SURFACE TO BE WELDED BY REMOVING PAINT OR GALVANIZATION TO BARE METAL USING POWER WIRE BRUSHING IN ACCORDANCE WITH SSPC-SP11, (STEEL STRUCTURES PAINTING COUNCIL). FOLLOWING POWER WIRE BRUSHING CONTRACTOR SHALL POLISH METAL SURFACE WITH HIGH SPEED GRINDER WITH 400+ GRIT SANDPAPER
- AFTER NEW STEEL INSTALLATION CONTRACTOR TO BRUSH PAINT (2) COATS OF ZRC OR ZINGA COLD GALVANIZATION COMPOUND PER

WELDING NOTES:

- 1. ALL WELDING TO THE EXISTING TOWER SHALL BE PERFORMED BY CERTIFIED WELDERS UTILIZING PROCEDURES QUALIFIED IN ACCORDANCE WITH AWS D1 1 AND AWS C5 4
- 2. CONTRACTOR SHALL COMPLY WITH AWS D1.1 FOR PROCEDURES, APPEARANCE AND QUALITY OF WELDS AND FOR METHODS USED IN CORRECTING WELDING. ALL WELDERS AND WELDING PROCESSES SHALL BE QUALIFIED IN ACCORDANCE WITH AWS "STANDARD QUALIFICATION PROCEDURES", CONTRACTOR SHALL SUBMIT CERTIFICATION OF WELDERS TO THE ENGINEER PRIOR TO COMMENCEMENT OF THE WORK
- CONTRACTOR RESPONSIBLE FOR TEMPORARY HEAT SHIELDING AS
- 4 CONTRACTOR RESPONSIBLE FOR VIEWING EXISTING TOWER FOR LOOSE AND FLAMMABLE MATERIAL PRIOR TO WELDING FLAT PLATE.
- 5. ALL WELDS TO BE VISUALLY INSPECTED BY A CERTIFIED WELD INSPECTOR PER AWS D1.1

BTS II, LLC

750 PARK OF COMMERCE DR, SUITE 200 BOCA RATON, FL 33487



SUITE 110 A-B




ENGINEERING INNOVATION FDH INFRASTRUCTURE SERVICES, LLC

6521 MERIDIEN DRIVE RALEIGH, NC 27616 PHONE: 919-755-1012 FAX: 919-755-1031 THE INFORMATION CONTAINED IN THIS SET OF

DOCUMENTS IS PROPRIETARY BY NATURE REPRODUCTION OR CAUSING TO BE REPRODUCED THE WHOLE OR ANY PART OF THESE DRAWINGS
WITHOUT THE PERMISSION OF FDH IS PROHIBITED

		SUBMITTALS		
REV	DATE	DESCRIPTION	BY	CHK'
0	03/17/2023	CONSTRUCTION	ZK	JRE

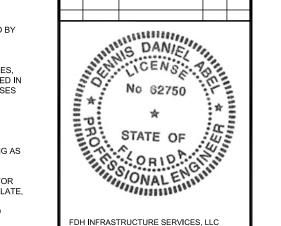

FDH INFRASTRUCTURE SERVICES, LLC DENNIS D. ABEL, PE STATE LICENNSE NO. 62750

FDH JOB NUMBER:

PR-008353

SITE ID: US-FL-7140

SITE NAME: **HUNGRY HOWIE**

T-MOBILE SITE ID:

A2B2227A

252835000000023020

ADDRESS:

3024 SPIRIT LAKE DRIVE WINTER HAVEN, FL 33880

SHEET TITLE:

PLATFORM STRUCTURAL NOTES 1

SHEET NUMBER:

SN-1

LOADING SPECIFICATIONS:

- GRAVITY LOADING (ASCE 7-16, CHAPTER, TABLE C3-1 & C3-2)
- REINFORCED CONCRETE = 150 LB/FT3
- STEEL = 490 LB/FT³
- STEEL GRATING = 13 LB/FT²
- EQUIPMENT = 1400 LB/FT²

LIVE LOADING (ASCE 7-16, CHAPTER 4)

- LIVE = 40 PSF
- HANDRAIL = 200 LB
- LADDER RUNG = 300 LB.
- LADDER RAIL = 100 LB

WIND LOADING (ASCE 7-16, CHAPTER 26, 29 AND APPENDIX D)

- RISK CATEGORY = II
- WIND SPEED = 140 MPH
- EXPOSURE = C
- BUILDING TYPE = OPEN STRUCTURE
- MRH = 2.5 FT
- KD = 0.85
- G = 0.85
- RATIO OF SOLID TO GROSS AREA = 0.20
- CF = 1.8
- F(z) = 55.1 PSF
- PER APPENDIX D, NO TORSIONAL FORCES WERE CONSIDERED IN

SEISMIC LOADING (ASCE 7-16, CHAPTER 11 AND 12)

- RISK CATEGORY = II
- SITE CLASS = D
- $S_S = 0.057$
- $S_1 = 0.03^{\circ}$
- FA = 1.6 FV = 2.4
- TI = 8
- SEISMIC DESIGN CATEGORY = A
- T = 0.05 SEC
- R = 3.5CS = 0.2930
- V = 0.13 KIP
- SEISMIC LOADING DOES NOT CONTROL THE ANALYSIS

LOADING COMBINATION FOR STRENGTH DESIGN (ASCE 7-16, CHAPTER 2)

- 1.4 DEAD
- 1.2 DEAD+ 1.6 LIVE + 0.5 SNOW
- 1.2 DEAD + 1.6 SNOW + 0.5 WIND
- 1.2 DEAD + 1.0 WIND + 1.0 LIVE + 0.5 SNOW 0.9 DFAD + 1.0 WIND
- 1.2 DEAD + 1.0 SEISMIC + 1.0 LIVE + 0.2 SNOW
- 0.9 DEAD + 1.0 SEISMIC
- 1.2 DEAD + 1.0 WIND + 2.0 FLOOD + 1.0 LIVE + 0.5 SNOW
- 0.9 DEAD + 1.0 WIND + 2.0 FLOOD

LOADING COMBINATION FOR SERVICEABILITY CONSIDERATIONS (ASCE 7-16, APPENDIX C AND COMMENTARIES

- VERTICAL DEFLECTION SHORT TERM LOADING: 1.0 DEAD + 1.0 LIVE
- VERTICAL DEFLECTION LONG TERM LOADING: 1.0 DEAD + 0.5 LIVE.
- DRIFT OF FRAMES:
- 10 DEAD + 0.5 LIVE + 1.0 Wa
- Wa= 92 MPH: WIND LOAD BASED ON SERVICEABILITY WIND SPEED

DEFLECTION DESIGN CRITERIA (ASCE 7-16, APPENDIX C AND

- VERTICAL DEFLECTION LIMIT: SPAN / 240
- HORIZONTAL DEFLECTION LIMIT: HEIGHT / 1400

FOUNDATION CONCRETE:

- WORK SHALL BE IN ACCORDANCE WITH THE LATEST ACI 318 BUILDING CODE REQUIREMENTS FOR REINFORCED CONCRETE.
- PROPORTIONS OF CONCRETE MATERIALS SHALL BE SUITABLE FOR THE INSTALLATION METHOD UTILIZED AND SHALL RESULT IN DURABLE CONCRETE FOR RESISTANCE TO LOCAL ANTICIPATED AGGRESSIVE ACTIONS. THE DURABILITY REQUIREMENTS OF ACI 318 CHAPTER 19 SHALL BE SATISFIED BASED ON THE CONDITIONS EXPECTED AT THE SITE. AS A MINIMUM, CONCRETE SHALL DEVELOP A COMPRESSIVE STRENGTH OF 4500 PSI IN 28 DAYS SATISFYING THE PARAMETERS BFI OW-
- SLUMP = 2 IN
- W/C = 0.45
- REBAR COVER = 3 IN
- REBAR GRADE (NOT TO BE WELDED) = ASTM-615-60
- REBAR GRADE (TO BE WELDED) = ASTM-706-60
- MAXIMUM AGGREGATE SIZE = 1.5 IN
- CONCRETE SHALL BE PLACED IN A MANNER THAT WILL PREVENT SEGREGATION OF CONCRETE MATERIALS, INFILTRATION OF WATER OR SOIL, AND OTHER OCCURRENCES THAT MAY DECREASE THE STRENGTH OR DURABILITY OF THE CONCRETE.
- LOOSE MATERIAL SHALL BE REMOVED FROM BOTTOM OF EXCAVATION PRIOR TO CONCRETE PLACEMENT. CONCRETE SHALL BE PLACED ON UNDISTURBED SOIL, AND LOOSE CUTTINGS SHALL BE REMOVED FROM SIDES OF EXCAVATION PRIOR TO CONCRETE PLACEMENT. UNDER NO CIRCUMSTANCES SHALL CONCRETE FALL THROUGH WATER
- IN COLD WEATHER CONDITIONS, WORK SHALL BE IN ACCORDANCE WITH ACI 306.1-90 (REAPPROVED 2002). SEE ACI 306 FOR DESCRIPTION OF COLD WEATHER CONDITIONS
- SULFATE RESISTANT CEMENT SHALL BE USED IN AREAS WHICH ARE KNOWN TO HAVE HIGH SULFATES IN SOIL AND GROUND WATER.
- SLUMP TEST SHALL BE PERFORMED ON-SITE TO ENSURE WORKABILITY
- ALL TEST CYLINDERS SHALL BE MADE AND CURED IN ACCORDANCE WITH ASTM C31. COMPRESSION TESTING SHALL BE DONE IN ACCORDANCE
- CYLINDERS TO BE BROKEN ON DAYS 7 AND 28. (2) ADDITIONAL CYLINDERS SHOULD BE AVAILABLE FOR ANY ADDITIONAL TESTING.
- A SUFFICIENT SAMPLING OF CONCRETE SHALL BE TAKEN TO ENSURE A FAIR REPRESENTATION OF THE CONCRETE USED FOR ALL SLUMP AND COMPRESSION TESTS. NON-COMFORMING MATERIAL SHALL NOT BE ACCEPTED BY CONTRACTOR.

FOUNDATION REINFORCEMENT:

- REINFORCEMENT SHALL BE DEFORMED AND CONFORM TO THE REQUIREMENTS OF ASTM A615 GRADE 60 UNLESS OTHERWISE NOTED. SPLICES IN REINFORCEMENT SHALL NOT BE ALLOWED UNLESS OTHERWISE NOTED
- REINFORCEMENT SHALL BE PROPERLY PLACED PRIOR TO ANY CONCRETE PLACEMENT. REINFORCING SHALL BE BRACED TO RETAIN PROPER DIMENSIONS DURING HANDLING AND THROUGHOUT PLACEMENT
- WELDING IS PROHIBITED ON REINFORCING STEEL AND EMBEDMENTS.
- MINIMUM CONCRETE COVER FOR REINFORCEMENT SHALL BE 3 INCHES. REBAR CHAIRS MUST BE USED TO ENSURE THE 3 INCH MINIMUM COVER. CONCRETE BLOCKS ARE NOT TO BE USED TO OBTAIN MINIMUM COVER
- ALL STIRRUPS SHALL HAVE MINIMUM 135° HOOKS PLUS 6*Db EXTENSIONS AT FREE ENDS AROUND CORNER LONGITUDINAL BAR UNLESS OTHERWISE NOTED

FOUNDATION NOTES:

- ALL WORK SHALL BE IN ACCORDANCE WITH ALL FEDERAL, STATE, AND LOCAL CODES AND ORDINANCES.
- PROCEDURES FOR THE PROTECTION OF EXCAVATIONS, EXISTING CONSTRUCTION AND UTILITIES SHALL BE ESTABLISHED PRIOR TO FOUNDATION INSTALLATION.
- ALL WORK PRESENTED ON THESE DRAWINGS IS TO BE COMPLETED BY THE CONTRACTOR UNLESS OTHERWISE NOTED AND/OR AGREED TO WITH FDH INFRASTRUCTURE SERVICES
- THE CONTRACTOR MUST HAVE EXPERIENCE IN PERFORMANCE OF WORK DESCRIBED HEREIN. BY ACCEPTANCE OF THIS ASSIGNMENT, THE CONTRACTOR IS ATTESTING THAT THEY HAVE SUFFICIENT EXPERIENCE, ABILITY, AND KNOWLEDGE OF WORK TO BE PERFORMED AND THAT THEY ARE PROPERLY LICENSED, REGISTERED, AND/OR ENSURED TO PERFORM THIS WORK
- 5. CONTRACTOR IS REQUIRED TO HAVE ALL NECESSARY INSPECTIONS PERFORMED BY THE LOCAL BUILDING CODE OFFICIAL OR AN
- 6. FOUNDATION DESIGN ASSUMES FIELD INSPECTIONS WILL BE PERFORMED TO VERIEY THAT CONSTRUCTION MATERIALS. INSTALLATION METHODS AND ANY ASSUMED DESIGN PARAMETERS ARE ACCEPTABLE BASED UPON CONDITIONS EXISTING AT THE SITE
- 7. ALL HARDWARE ASSEMBLY AND MANUFACTURER'S INSTRUCTIONS SHALL BE FOLLOWED; ANY CONTRADICTION BETWEEN THE MANUFACTURER'S RECOMMENDATIONS AND THESE DRAWINGS ARE TO BE BROUGHT IMMEDIATELY TO THE ATTENTION OF THE ENGINEER
- 8. ANY CONTRACTOR INSTALLING ADHESIVE ANCHORING SYSTEMS SHALL BE TRAINED, IN PERSON BY A MANUFACTURER'S REPRESENTATIVE, ON THE PROPER INSTALLATION TECHNIQUES. THIS TRAINING SHALL INCLUDE PROPER DRILLING, HOLE CLEANING, AND INSTALLATION METHODS FOR THE ADHESIVE ANCHORING SYSTEM AND CONSTRUCTION CONDITIONS ON THIS PROJECT. ALL TRAINING TO BE CONDUCTED PRIOR TO CREWS STEPPING ON SITE IT IS THE RESPONSIBILITY OF THE CONTRACTOR TO CONTACT MANUFACTURER REPRESENTATIVE TO SET UP TRAINING. FDH IS NOT RESPONSIBLE FOR ANY COST OCCURRED FOR OR DURING ADHESIVE ANCHORING SYSTEM TRAINING
- CONTRACTOR IS SOLELY RESPONSIBLE FOR MEANS AND METHODS OF CONSTRUCTION INCLUDING BUT NOT LIMITED TO INITIATING MAINTAINING, LAYOUT, AND SUPERVISING ALL SAFETY PRECAUTIONS AND PROGRAMS IN CONNECTION WITH THE WORK. CONTRACTOR IS SOLELY RESPONSIBLE FOR ENSURING THE WORK COMPLIES WITH ALL APPLICABLE SAFETY CODES AND REGULATIONS.
- 10 ALL DIMENSIONS AND/OR ELEVATIONS OR SIMILAR EXISTING CONDITIONS SHOWN ON THE DRAWING ARE TO BE FIFLD VERIFIED BY THE CONTRACTOR PRIOR TO BEGINNING ANY MATERIAL ORDERING. FABRICATION, OR CONSTRUCTION WORK. ANY DISCREPANCIES ARE TO BE IMMEDIATELY BROUGHT TO THE ATTENTION OF THE ENGINEER/OWNER. DISCREPANCIES MUST BE RESOLVED BEFORE CONTRACTOR IS TO PROCEED WITH THE WORK.
- 11. FOUNDATION DESIGN HAS BEEN DEVELOPED IN ACCORDANCE WITH THE LIMITS OF THE SUBSURFACE DATA PROVIDED. APPLICABLE CODES ARE ACI-318. SHOULD SUBSURFACE CONDITIONS VARY FROM THOSE VALUES USED IN THE DESIGN, THEN FDH INFRASTRUCTURE SHOULD BE NOTIFIED IMMEDIATELY.
- 12. FOUNDATION BACKFILL SHALL BE PLACED IN 8-INCH MAXIMUM LAYERS AND COMPACTED TO 95% OF MAXIMUM DRY DENSITY AND WITHIN ±2% OF THE OPTIMUM MOISTURE CONTENT AS DETERMINED BY ASTM D-698 (STANDARD PROCTOR). ADDITIONALLY, STRUCTURAL BACKFILL MUST HAVE A MINIMUM COMPACTED UNIT WEIGHT OF 100 LBS PER
- 13. ANY EXPOSED EDGES OF CONCRETE SHALL BE CHAMFERED 3/4" X 3/4" MINIMUM
- 14. CONTRACTOR TO PROVIDE A "SAFE WORKING" SOIL SLOPE AND/OR TEMPORARY SOIL SHORING PER ALL APPLICABLE SAFETY CODES & REGULATIONS DURING CONSTRUCTION.
- 15. THE FOUNDATION HAS BEEN DESIGNED BASED ON THE GEOTECHNICAL REPORT BY FDH INFRASTRUCTURE SERVICES, SITE NAME: HUNGRY HOWIE, PROJECT NUMBER PR-008353

CONCRETE TESTING:

- SLUMP TEST SHALL BE PERFORMED ON-SITE TO ENSURE WORKABILITY OF CONCRETE.
- ALL TEST CYLINDERS SHALL BE MADE AND CURED IN ACCORDANCE WITH ASTM C31. COMPRESSION TESTING SHALL BE DONE IN ACCORDANCE WITH ASTM C39
- 3 CYLINDERS TO BE BROKEN ON DAYS 7 AND 28 (2) ADDITIONAL CYLINDERS SHOULD BE AVAILABLE FOR ANY ADDITIONAL TESTING.
- 4. A SUFFICIENT SAMPLING OF CONCRETE SHALL BE TAKEN TO ENSURE A FAIR REPRESENTATION OF THE CONCRETE USED FOR ALL SLUMP AND COMPRESSION TESTS. NON-COMFORMING MATERIAL SHALL NOT BE ACCEPTED BY CONTRACTOR.

BASE PLATE GROUT:

- 1 WORK SHALL BE IN ACCORDANCE WITH THE LATEST VERSION OF ACL 318 - "BUILDING CODE REQUIREMENTS FOR REINFORCED CONCRETE.
- 2. AS A MINIMUM, GROUT SHALL DEVELOP A COMPRESSIVE STRENGTH OF 5000 PSI MIN. IN 28 DAYS
- 3. GROUT SHALL BE PLACED IN A MANNER THAT WILL PREVENT SEGREGATION OF GROUT MATERIALS
- 4. LOOSE MATERIAL SHALL BE REMOVED PRIOR TO GROUT PLACEMENT. ANY FAYING SURFACES MUST BE FREE OF DIRT, GREASE, SCALE, ETC., AND UNSOUD GROUT MUST BE CHIPPED OUT.
- 5. MATERIAL SPECIFICATIONS SHALL BE IN ACCORDANCE WITH ASTM C1107-02. STANDARD SPECIFICATIONS FOR PACKAGED DRY. HYDRAULIC-CEMENT GROUT (NONSHRINK)
- 6. LEVELING NUT TIGHTNESS CHECK: WHEN CHECKING FOR NUT TIGHTNESS, ALWAYS TURN THE SPUD WRENCH IN THE DIRECTION TO TIGHTEN THE NUT AGAINST THE BASE PLATE. USING THE SPUD WRENCH AND THE FULL EFFORT OF A PERSON. CHECK THE LEVELING NUT FOR TIGHTNESS AND THE NUT ATOP THE BASE PLATE FOR
- 7. PLACEMENT TEMPERATURES AND CURING SHALL BE PER MANUFACTURER'S RECOMMENDATIONS
- 8. THE GROUT SHALL BE INSTALLED TO PROVIDE BEARING TO THE ENTIRE BASE PLATE SURFACE.

BTS II, LLC

750 PARK OF COMMERCE DR, SUITE 200 BOCA RATON, FL 33487






SUITE 110 A-B

TAMPA EL 33634

ENGINEERING INNOVATION FDH INFRASTRUCTURE SERVICES, LLC 6521 MERIDIEN DRIVE RALEIGH, NC 27616 PHONE: 919-755-1012 FAX: 919-755-1031

THE INFORMATION CONTAINED IN THIS SET OF DOCUMENTS IS PROPRIETARY BY NATURE REPRODUCTION OR CAUSING TO BE REPRODUCED THE WHOLE OR ANY PART OF THESE DRAWINGS
WITHOUT THE PERMISSION OF FDH IS PROHIBITED

SUBMITTALS REV DATE DESCRIPTION ВУ СНК 0 03/17/2023 CONSTRUCTION ZK JRB

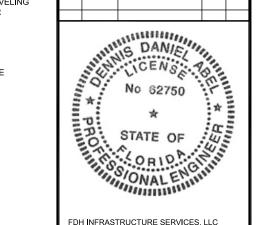

FDH INFRASTRUCTURE SERVICES, LLC DENNIS D. ABEL, PE STATE LICENNSE NO. 62750

> FDH JOB NUMBER: PR-008353

SITE ID: US-FL-7140

SITE NAME: **HUNGRY HOWIE**

T-MOBILE SITE ID:

A2B2227A

252835000000023020

ADDRESS: 3024 SPIRIT LAKE DRIVE


WINTER HAVEN, FL 33880 SHEET TITLE:

PLATFORM STRUCTURAL NOTES 2

SHEET NUMBER:


SN-2


 NEW ANCHOR RODS AND TEMPLATE PLATES SHALL BE LOCATED AT THE CENTER OF THE NEW CONCRETE PIER.

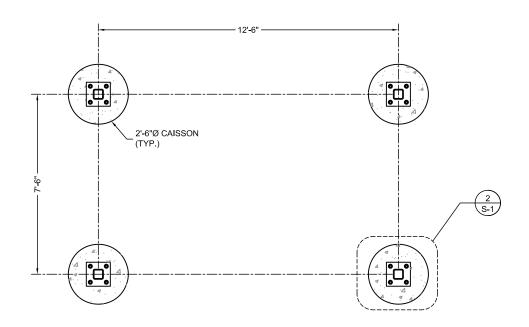

PLATFORM FOUNDATION PLAN VIEW



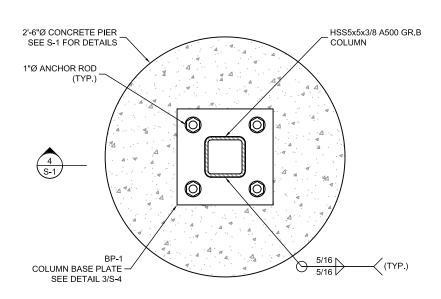

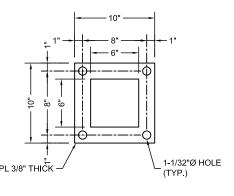

CONCRETE PIER & LADDER FOOT PAD PLAN VIEW




ANCHOR ROD TEMPLATE PLAN VIEW



FOUNDATION MATERIAL LIST PART QTY.1 LENGTH DESCRIPTION SHAPE NO. R-1 #6 REBAR 10'-0"± #4 REBAR W/ 135° HOOKS 3" O.C. FROM +0'-3" TO -2'-9" R-2² 20 7'-11"± 12" O.C. FROM -2'-9" TO -9'-9 1 "Ø F1554 GRADE 105 ANCHOR RODS 4'-0"± TEMPLATE PLATE (SEE DETAIL 3 ON THIS SHEET) 20 HEAVY HEX NUT ROUND HARDENED WASHER 4500 PSI CONCRETE 2.0± CU. YD.

- 1. QUANTITIES REFLECT INFORMATION FOR (1) FOUNDATION, (4) REQUIRED.
- 2. MINIMUM BEND DIAMETER OF REBAR SHOULD BE UTILIZED. USE 6*Db UNLESS OTHERWISE NOTED.

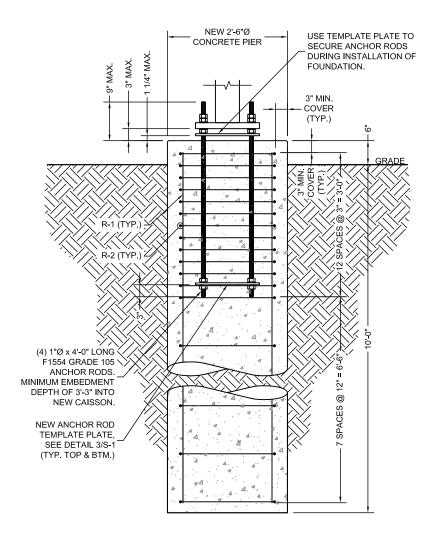

FOUNDATION REINFORCEMENT SECTION VIEW

4 DETAIL
S-1 SCALE: NTS

VB BTS II, LLC

750 PARK OF COMMERCE DR, SUITE 200 BOCA RATON, FL 33487





TAMPA, FL 33634

ENGINEERING INNOVATION

FDH INFRASTRUCTURE SERVICES, LLC 6521 MERIDIEN DRIVE RALEIGH, NC 27616 PHONE: 919-755-1012 FAX: 919-755-1031

THE INFORMATION CONTAINED IN THIS SET OF DOCUMENTS IS PROPRIETARY BY NATURE. REPRODUCTION OR CAUSING TO BE REPRODUCED THE WHOLE OR ANY PART OF THESE DRAWINGS WITHOUT THE PERMISSION OF FDH IS PROHIBITED.

SUBMITTALS

REV	DATE	DESCRIPTION	BY	CHK'E
0	03/17/2023	CONSTRUCTION	ZK	JRB



FDH INFRASTRUCTURE SERVICES, LLC DENNIS D. ABEL, PE STATE LICENNSE NO. 62750

FDH JOB NUMBER:

PR-008353

SITE ID: US-FL-7140

SITE NAME:

HUNGRY HOWIE

T-MOBILE SITE ID:

A2B2227A

DADCEI.

252835000000023020


ADDRESS:

3024 SPIRIT LAKE DRIVE WINTER HAVEN, FL 33880


SHEET TITLE:

PLATFORM FOUNDATION DETAILS

SHEET NUMBER:

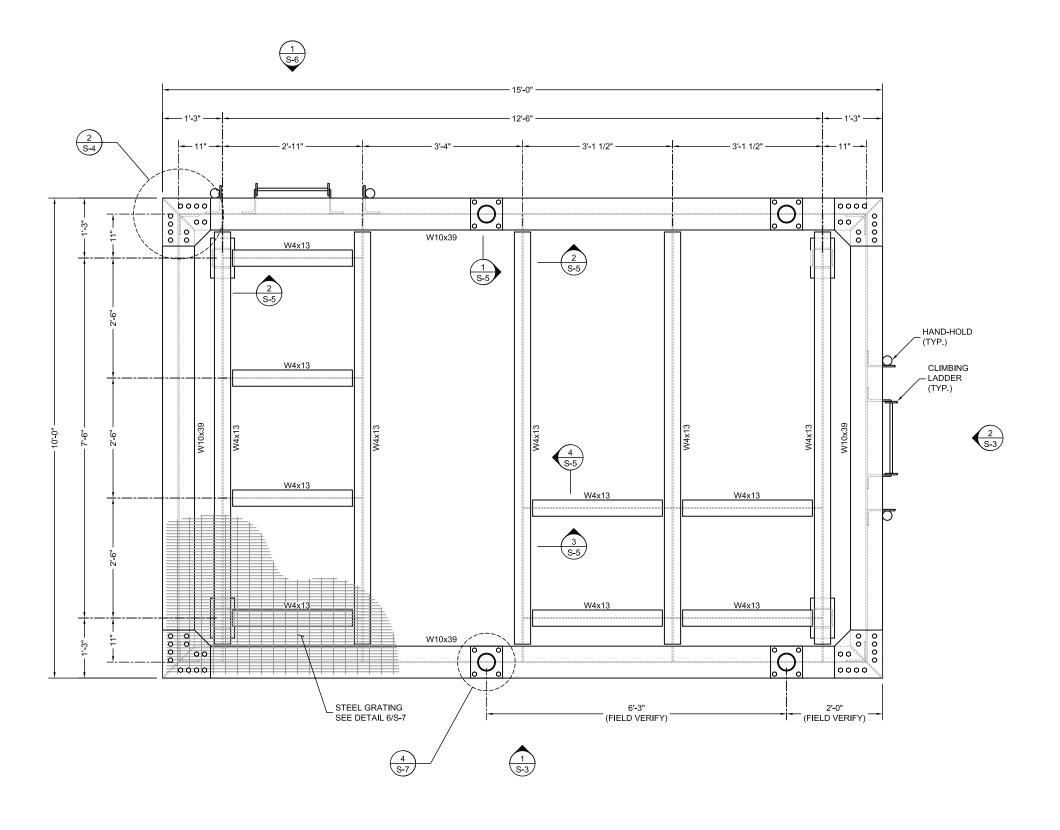

STEEL PLATFORM FRAMING PLAN VIEW

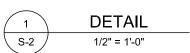

BTS II, LLC

750 PARK OF COMMERCE DR, SUITE 200 BOCA RATON, FL 33487






ENGINEERING INNOVATION

FDH INFRASTRUCTURE SERVICES, LLC 6521 MERIDIEN DRIVE RALEIGH, NC 27616 PHONE: 919-755-1012 FAX: 919-755-1031

THE INFORMATION CONTAINED IN THIS SET OF DOCUMENTS IS PROPRIETARY BY NATURE. REPRODUCTION OR CAUSING TO BE REPRODUCED THE WHOLE OR ANY PART OF THESE DRAWINGS WITHOUT THE PERMISSION OF FDH IS PROHIBITED.

SUBMITTALS

REV	DATE	DESCRIPTION	BY	CHK'D
0	03/17/2023	CONSTRUCTION	ZK	JRB

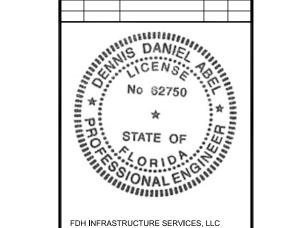

FDH INFRASTRUCTURE SERVICES, LLC DENNIS D. ABEL, PE STATE LICENNSE NO. 62750

FDH JOB NUMBER:

PR-008353

SITE ID: US-FL-7140

SITE NAME:

HUNGRY HOWIE

T-MOBILE SITE ID:

A2B2227A


252835000000023020


ADDRESS:

3024 SPIRIT LAKE DRIVE WINTER HAVEN, FL 33880

PLATFORM FRAMING PLAN

SHEET NUMBER:

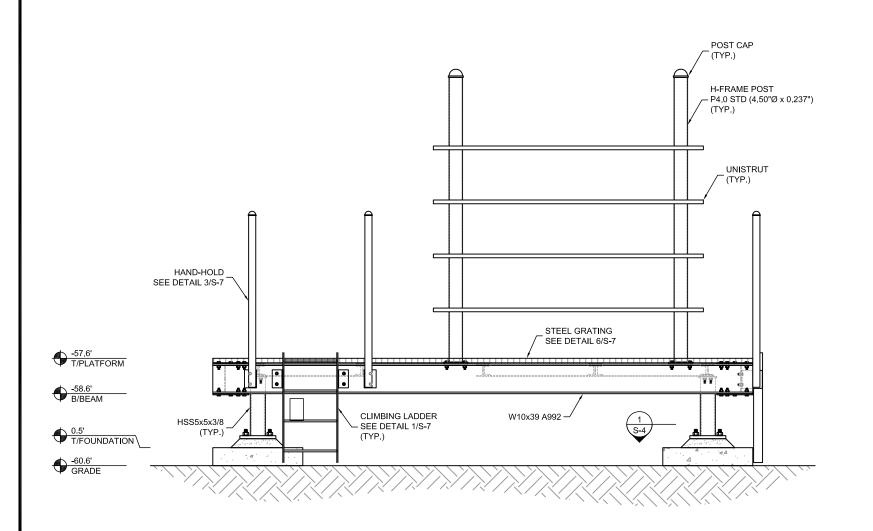

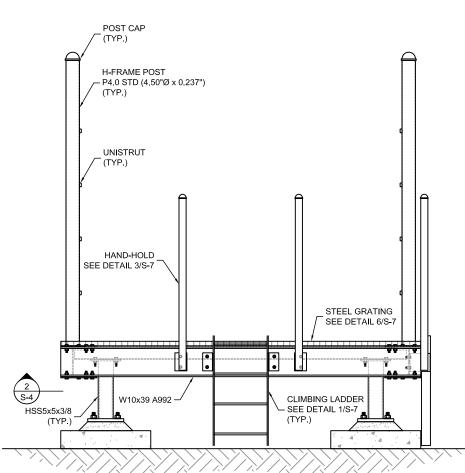

STEEL PLATFORM FRONT VIEW



STEEL PLATFORM SIDE VIEW

ELEVATION 3/8" = 1'-0"

BTS II, LLC

750 PARK OF COMMERCE DR, SUITE 200 BOCA RATON, FL 33487






ENGINEERING INNOVATION FDH INFRASTRUCTURE SERVICES, LLC 6521 MERIDIEN DRIVE RALEIGH, NC 27616 PHONE: 919-755-1012 FAX: 919-755-1031

THE INFORMATION CONTAINED IN THIS SET OF DOCUMENTS IS PROPRIETARY BY NATURE.
REPRODUCTION OR CAUSING TO BE REPRODUCED
THE WHOLE OR ANY PART OF THESE DRAWINGS
WITHOUT THE PERMISSION OF FDH IS PROHIBITED.

SUBMITTALS

REV	DATE	DESCRIPTION	BY	СНК
0	03/17/2023	CONSTRUCTION	ZK	JR

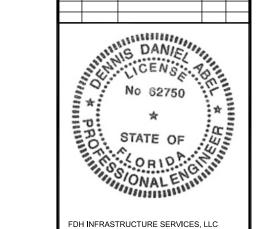

FDH INFRASTRUCTURE SERVICES, LLC DENNIS D. ABEL, PE STATE LICENNSE NO. 62750

FDH JOB NUMBER:

PR-008353

SITE ID:

US-FL-7140

SITE NAME: HUNGRY HOWIE

T-MOBILE SITE ID:

A2B2227A

252835000000023020


ADDRESS:

3024 SPIRIT LAKE DRIVE WINTER HAVEN, FL 33880

SHEET TITLE:


PLATFORM PROFILES

SHEET NUMBER:

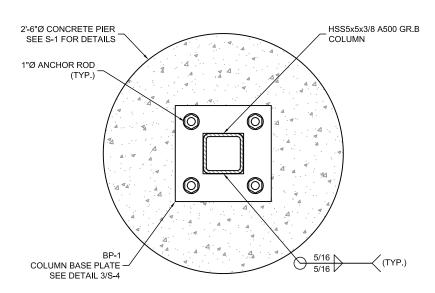


COLUMN BASE PLATE PLAN VIEW



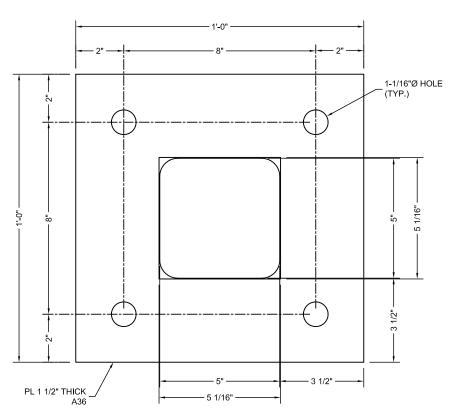


BP-1 COLUMN BASE PLATE TOP VIEW

3	DETAIL
S-4	NTS

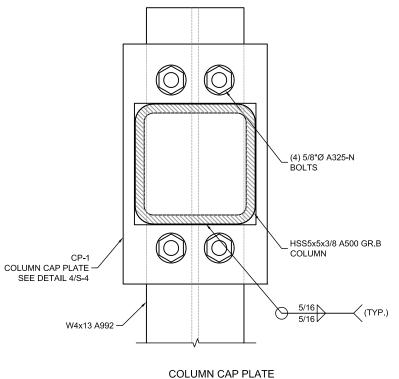

PLAN VIEW



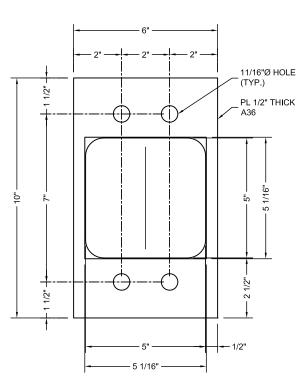

CP-1 COLUMN CAP PLATE FRONT VIEW

4	DETAIL
S-4	NTS

BTS II, LLC

750 PARK OF COMMERCE DR, SUITE 200 BOCA RATON, FL 33487






TAMPA, FL 33634

ENGINEERING INNOVATION

FDH INFRASTRUCTURE SERVICES, LLC 6521 MERIDIEN DRIVE RALEIGH, NC 27616 PHONE: 919-755-1012 FAX: 919-755-1031

THE INFORMATION CONTAINED IN THIS SET OF DOCUMENTS IS PROPRIETARY BY NATURE.
REPRODUCTION OR CAUSING TO BE REPRODUCED
THE WHOLE OR ANY PART OF THESE DRAWINGS
WITHOUT THE PERMISSION OF FDH IS PROHIBITED.

SUBMITTALS REV DATE DESCRIPTION 0 03/17/2023 CONSTRUCTION ZK JRB

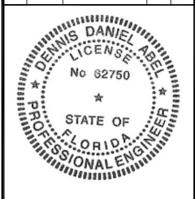

FDH INFRASTRUCTURE SERVICES, LLC DENNIS D. ABEL, PE STATE LICENNSE NO. 62750

FDH JOB NUMBER:

PR-008353

SITE ID:

US-FL-7140 SITE NAME:

HUNGRY HOWIE

T-MOBILE SITE ID: A2B2227A

252835000000023020


ADDRESS:

3024 SPIRIT LAKE DRIVE WINTER HAVEN, FL 33880

SHEET TITLE:


PLATFORM CONNECTION DETAILS I

SHEET NUMBER:

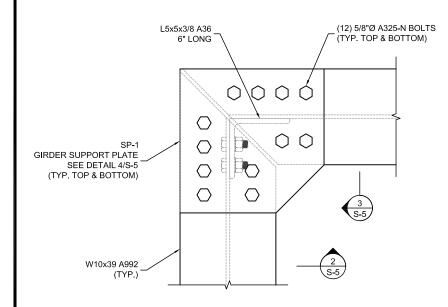


PERIMETER GIRDER CONNECTION DETAIL PLAN VIEW



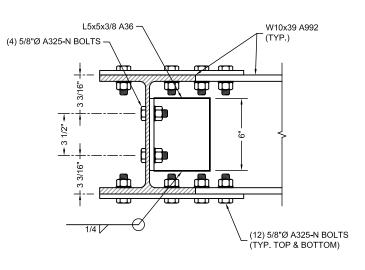


PERIMETER GIRDER CONNECTION DETAIL SIDE VIEW

2	DETAIL
S-5	NTS

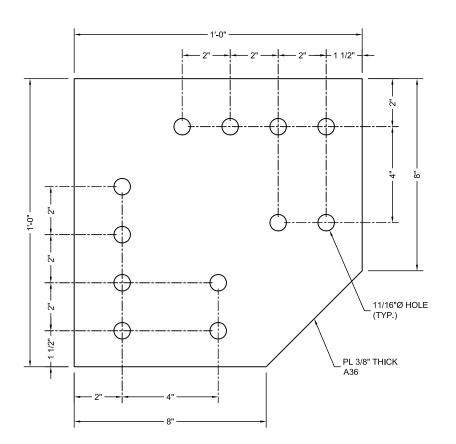

SP-1 GIRDER SUPPORT PLATE FRONT VIEW



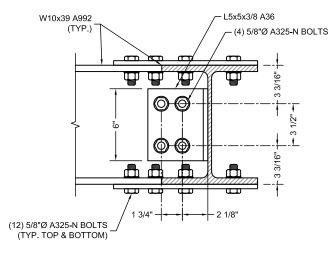

PERIMETER GIRDER CONNECTION DETAIL SIDE VIEW

3	DETAIL	
S-5	NTS	_



750 PARK OF COMMERCE DR, SUITE 2 BOCA RATON, FL 33487






ENGINEERING INNOVATION

FDH INFRASTRUCTURE SERVICES, LLC
6521 MERIDIEN DRIVE RALEIGH, NC 27616
PHONE: 919-755-1021

TAMPA, FL 33634

THE INFORMATION CONTAINED IN THIS SET OF DOCUMENTS IS PROPRIETARY BY NATURE.

SUBMITTALS					
REV	DATE	DESCRIPTION	BY	CHK'D	
0	03/17/2023	CONSTRUCTION	ZK	JRB	

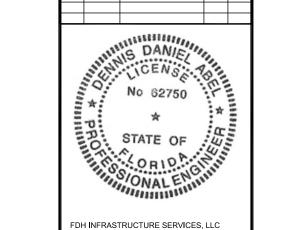

FDH INFRASTRUCTURE SERVICES, LLC DENNIS D. ABEL, PE STATE LICENNSE NO. 62750

FDH JOB NUMBER:

PR-008353

SITE ID:

US-FL-7140 SITE NAME:

HUNGRY HOWIE

T-MOBILE SITE ID:

A2B2227A

, LDZZZ.

252835000000023020


ADDRESS:


3024 SPIRIT LAKE DRIVE WINTER HAVEN, FL 33880

SHEET TITLE:

PLATFORM CONNECTION DETAILS II

SHEET NUMBER:

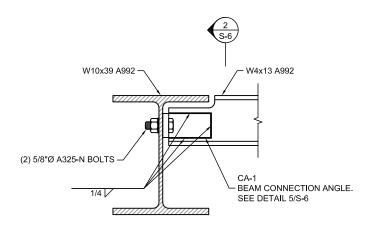

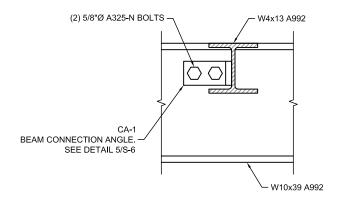


BEAM TO GIRDER CONNECTION ELEVATION VIEW




BEAM TO GIRDER CONNECTION ELEVATION VIEW



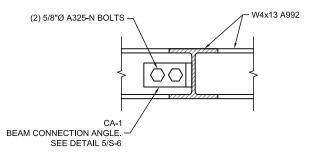

BEAM TO GIRDER CONNECTION ELEVATION VIEW



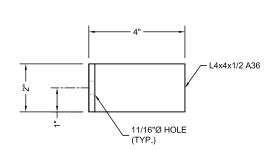

SIDE VIEW

FRONT VIEW

1 3/4"

- 1 3/8'

- L4x4x1/2 A36

11/16"Ø HOLE

CA-1 BEAM CONNECTION ANGLE FRONT & SIDE VIEW





750 PARK OF COMMERCE DR, SUITE 200 BOCA RATON, FL 33487





TAMPA, FL 33634

FDH INFRASTRUCTURE SERVICES, LLC 6521 MERIDIEN DRIVE RALEI GH, NC 27616 PHONE: 919-755-1012 FAX: 919-755-1031

THE INFORMATION CONTAINED IN THIS SET OF DOCUMENTS IS PROPRIETARY BY NATURE. REPRODUCTION OR CAUSING TO BE REPRODUCED THE WHOLE OR ANY PART OF THESE DRAWINGS WITHOUT THE PERMISSION OF FDH IS PROHIBITED.

SUBMITTALS					
REV	DATE	DESCRIPTION	BY	CHK'D	
0	03/17/2023	CONSTRUCTION	ZK	JRB	



FDH INFRASTRUCTURE SERVICES, LLC DENNIS D. ABEL, PE STATE LICENNSE NO. 62750

FDH JOB NUMBER:

PR-008353

SITE ID:

US-FL-7140

SITE NAME: HUNGRY HOW**I**E

T-MOBILE SITE ID:

A2B2227A

, LDLLLI,

252835000000023020

ADDRESS:


3024 SPIRIT LAKE DRIVE WINTER HAVEN, FL 33880

SHEET TITLE:

PLATFORM CONNECTION DETAILS III

SHEET NUMBER:

S-6

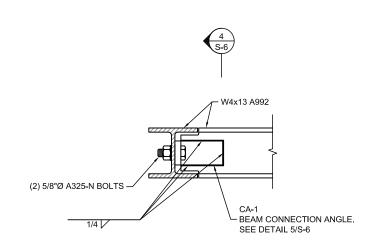


BEAM TO GIRDER CONNECTION


ELEVATION VIEW

SECTION

NTS

3

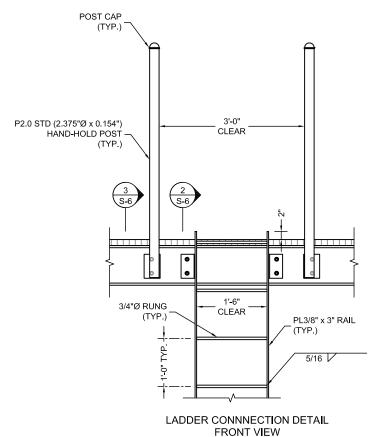

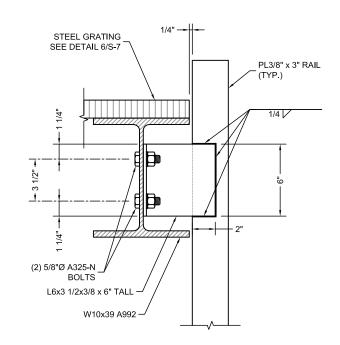


LADDER CONNECTION DETAIL

SIDE VIEW

SECTION

NTS


S-7

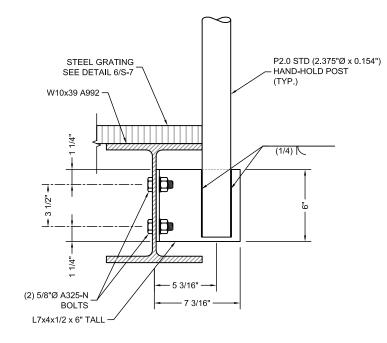









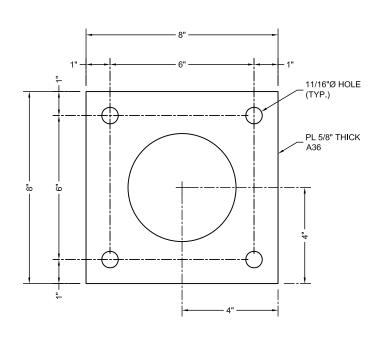

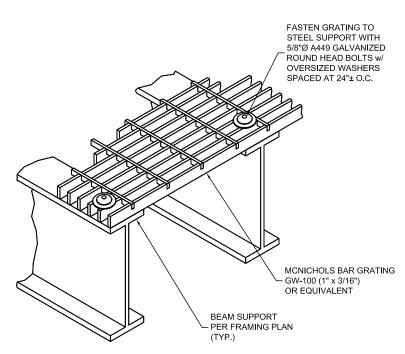

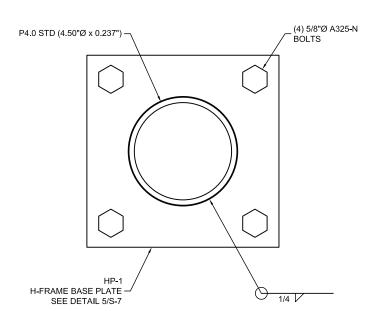

HP-1 H-FRAME BASE PLATE FRONT VIEW

S-7

4	DETAIL	
S-7	NTS	

H-FRAME POST DETAIL

PLAN VIEW



NTS

ISOMETRIC VIEW

GRATING CONNECTION DETAIL

6 DETAIL
S-7 NTS



750 PARK OF COMMERCE DR, SUITE 200 BOCA RATON, FL 33487






ENGINEERING INNOVATION

FDH INFRASTRUCTURE SERVICES, LLC
6521 MERIDIEN DRIVE RALEIGH, NC 27616
PHONE: 919-755-1012 FAX: 919-755-1031

THE INFORMATION CONTAINED IN THIS SET OF DOCUMENTS IS PROPRIETARY BY NATURE. REPRODUCTION OR CAUSING TO BE REPRODUCED THE WHOLE OR ANY PART OF THESE DRAWINGS WITHOUT THE PERMISSION OF FOH IS PROHIBITED.

WITHOUT THE PERMISSION OF FUH IS PROHIBITED.					
SUBMITTALS					
REV	DATE	DESCRIPTION	BY	CHK'E	
0	03/17/2023	CONSTRUCTION	ZK	JRB	

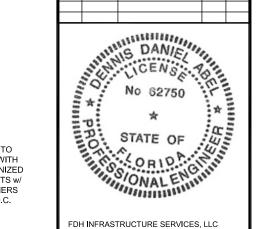

FDH INFRASTRUCTURE SERVICES, LLC DENNIS D. ABEL, PE STATE LICENNSE NO. 62750

FDH JOB NUMBER:

PR-008353

SITE ID:

US-FL-7140

SITE NAME: HUNGRY HOWIE

T-MOBILE SITE ID:

A2B2227A

252835000000023020

ADDRESS:

3024 SPIRIT LAKE DRIVE WINTER HAVEN, FL 33880

SHEET TITLE:

PLATFORM CONNECTION DETAILS IV

SHEET NUMBER:





750 PARK OF COMMERCE DR, SUITE 200 BOCA RATON, FL 33487





ENGINEERING INNOVATION

FDH INFRASTRUCTURE SERVICES, LLC

6521 MERIDIEN DRIVE RALEIGH, NC 27616
PHONE: 919-755-1012 FAX: 919-755-1031

THE INFORMATION CONTAINED IN THIS SET OF DOCUMENTS IS PROPRIETARY BY NATURE. REPRODUCTION OR CAUSING TO BE REPRODUCED THE WHOLE OR ANY PART OF THESE DRAWINGS WITHOUT THE PERMISSION OF FDH IS PROHIBITED.

SUBMITTALS

REV	DATE	DESCRIPTION	BY	CHK'D
0	03/17/2023	CONSTRUCTION	ZK	JRB



FDH INFRASTRUCTURE SERVICES, LLC DENNIS D. ABEL, PE STATE LICENNSE NO. 62750

FDH JOB NUMBER:

PR-008353

SITE ID:

US-FL-7140

SITE NAME: HUNGRY HOW**I**E

T-MOBILE SITE ID:

A2B2227A

PARCEL: 252835000000023020

3024 SPIRIT LAKE DRIVE WINTER HAVEN, FL 33880

SHEET TI

LANDSCAPE SITE PLAN

SHEET NUMBER

L-1